### City of Moraine Municipal Building

4200 Dryden Road Moraine, OH 45439

### OWNER

CITY OF MORAINE 4200 DRYDEN ROAD MORAINE OH 45439 937.535.1051

CONTACT: BOBBY ENGLE BUILDING AND MAINTENANCE SUPERINTENDANT

### DESIGN TEAM

### ARCHITECT:



### PME ENGINEERS:

Helmig Lienesch LLC Consulting Engineers

410 South Jefferson Street Dayton, OH 45402

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HI-IHVAC - PARTIAL FIRST FLOOR PLANS - DEMOLITION & REVISED HVAC - PARTIAL ROOF PLAN - DEMOLITION & REVISED HVAC - PARTIAL GROUND FLOOR PLAN & HVAC SCHEDULES H2-I HVAC-DUCTWORK CLEANING - PARTIAL FLOOR PLANS E|-| ELECTRICAL PARTIAL FIRST FLOOR DEMOLITION PLAN

ELECTRICAL PARTIAL FIRST FLOOR LIGHTING PLAN


ELECTRICAL PARTIAL FIRST FLOOR SYSTEMS PLAN ELECTRICAL PANEL BOARD SCHEDULES

### VICINITY MAP

FPI-I

P|-|

E2-I

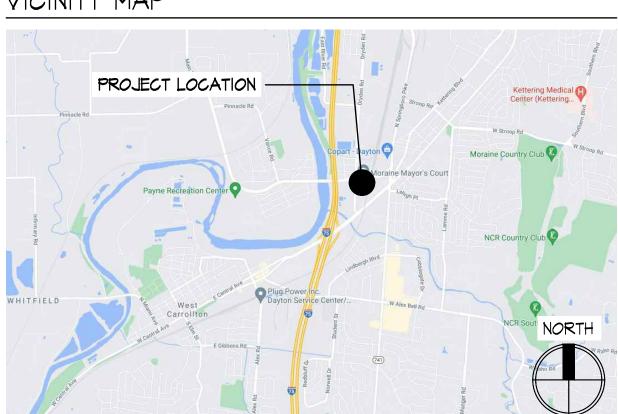

### CODE REVIEW

<u>zoning:</u>

INTERIOR ALTERATIONS TO EXISTING OFFICE SPACE. NO CHANGE IN <u>DESCRIPTION:</u> OCCUPANCY OR USE. JURISDICTION: CITY OF MORAINE, MONTGOMERY COUNTY 906: PORTABLE FIRE EXTINGUISHERS IN ACCORDANCE WITH FIRE CODE, MORAINE F.D. 907.2.2 - FIRE ALARM NOT REQUIRED - NOT PROVIDED. NO CHANGE, EXISTING PARKING TO REMAIN. PARKING:

BUILDING CODE: OHIO BUILDING CODE 2017 [OBC]:

CHAPTER 3: USE AND OCCUPANCY CLASSIFICATION USE GROUP: B. BUSINESS - NO CHANGE [AREA OF WORK] B, BUSINESS / S-2, GARAGE [ENTIRE BUILDING]

CHAPTER 5: GENERAL BUILDING HEIGHT AND AREA TABLE 504.3: ALLOWABLE HEIGHT: B, SPRINKLERED, TYPE II B = 75' EXISTING - NO CHANGE [± 25'] TABLE 505.4: ALLOWABLE STORIES: B, SPRINKLERED, TYPE II B = 4 STORIES EXISTING - NO CHANGE [2 STORIES]

TABLE 506.2: ALLOWABLE AREA: B, SM, TYPE II B = 69,000 SF PER STORY EXISTING BUILDING MAIN LEVEL AREA: +/- 26,574 S.F. [OK] BASEMENT AREA: +/- 11,098 S.F. [OK]

+/- 37,672 S.F.

+/- 11,877 S.F. NONSEPARATED OCCUPANCIES [B USE IS MOST RESTRICTIVE]

TOTAL BUILDING AREA:

### CHAPTER 6: TYPES OF CONSTRUCTION 602.2: CONSTRUCTION TYPE: II B

PRIMARY STRUCTURAL FRAME = 0 HOUR EXTERIOR BEARING WALLS = O HOUR INTERIOR BEARING WALLS = O HOUR NON-BEARING WALLS = O HOUR FLOOR CONSTRUCTION = O HOUR ROOF CONSTRUCTION = O HOUR

CHAPTER 7: FIRE-RESISTANCE RATED CONSTRUCTION TABLE 705.8: MAXIMUM AREA OF EXTERIOR WALL OPENINGS UNPROTECTED, GREATER THAN 30' = UNLIMITED OPENINGS PERMITTED

### CHAPTER 8: INTERIOR FINISHES

TABLE 803.II: INTERIOR WALL AND CEILING FINISH REQUIREMENTS USE B. SPRINKLERED EXIT ENCLOSURES AND PASSAGEWAYS: CLASS B CORRIDORS: CLASS C ROOMS AND ENCLOSED SPACES: CLASS C

CHAPTER 9: FIRE PROTECTION SYSTEMS 903.2. - USE GROUP B: AUTOMATIC FIRE SPRINKLER SYSTEM NOT REQUIRED - NFPA 13 SYSTEM EXISTS IN BUILDING - MODIFICATIONS AS REQ'D BY NEW WORK, SEE SHEET FPI-I

CHAPTER IO: MEANS OF EGRESS TABLE 1004.1.2: BUSINESS:

SERVICE SINK

I / 100 S.F. = 377 OCCUPANTS - NO CHANGE [BUILDING TOTAL] TABLE 1005.3: EGRESS WIDTH OCCUPANCY 3TT X .20 = 75.4"

ACTUAL = 3 DOORS AT 36" AND 4 DOORS AT 72" [OK - EXISTING - NO CHANGE] NO CHANGE TO EXISTING BUILDING EGRESS TABLE 1006.3.1: MINIMUM NUMBER OF EXITS 0-500 OCCUPANTS = 2 [7 EXITS PROVIDED] ACCESSIBLE MEANS OF EGRESS: EXISTING ACCESSIBLE MEANS OF EGRESS AT

MAIN ENTRY TO REMAIN... TABLE 1017.2: BUSINESS USE WITH SPRINKLER SYSTEM = 300' TRAVEL DISTANCE ACTUAL TRAVEL DISTANCE = +/- 100'-8" TABLE 1020.1: CORRIDORS SERVING MORE THAN 30 PERSONS = 0 HOUR WITH SPRINKLER

CHAPTER II: ACCESSIBILITY - SAFE HARBOR - ANSI ICC 117.1 2009 ACCESSIBLE ROUTE PROVIDED - FRONT ENTRANCE, EXISTING ACCESSIBLE ENTRANCE - PROVIDED, EXISTING

ACCESSIBLE TOILET ROOMS - PROVIDED - 2 NEW ADDED IN AREA OF WORK. ACCESSIBLE SIGNAGE - PROVIDED FOR TOILET ROOMS, AND OTHER AREAS REQUIRED BY ANSI/ADAAG - EXISTING

CHAPTER 29: PLUMBING SYSTEMS TABLE 2902.1: OCCUPANT LOAD OF 3TT / 2 = 189 EACH MEN / WOMEN

TABLE 1020.2: CORRIDOR WIDTH: MIN. 44" - EXISTING


I NEW MEN'S AND I NEW WOMEN'S TOILET ROOM ADDED FOR CONVENIENCE WITHIN SPACE. TOTAL PLUMBING COUNT IS BEING INCREASED DESPITE NO CHANGE IN OCCUPANCY.

COMMON AREA PLUMBING FACILITIES PROVIDED [EXISTING, NO CHANGE]

MEN		NEW	EXISTING	TOTAL	REQUIRED
WATERCLOSETS	[1/50]		5 / 4 URN	6/4	4 [OK]
LAVATORIES	[1/80]	1	5	6	3 [OK]
SHOWER			4	4	
MOMEN		NEW	EXISTING	TOTAL	REQUIRED
WATERCLOSETS	[1/50]	1	6	7	4 [OK]
LAVATORIES	[1/80]	1	5	6	3 [OK]
SHOWER			2	2	
DRINKING FOUNTA	AINS	EXISTING T	O REMAIN		

EXISTING TO REMAIN

### WALL / SYMBOL LEGEND

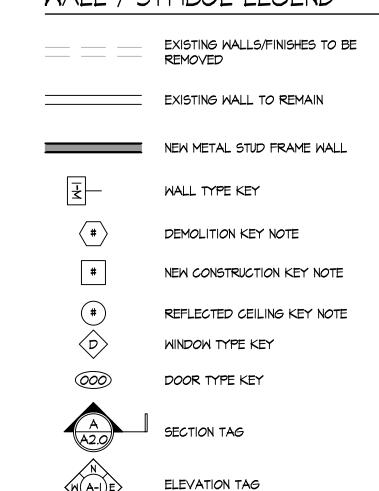

ADAAG	AMERICANS WITH DISABILITIES ACT ACCESSIBILITY GUIDELINES
AFF	ABOVE FINISH FLOOR
ALUM	ALUMINUM
ATC	ACOUSTIC TILE CEILING
BLK <i>G</i>	BLOCKING
BET	BETWEEN
BRG	BEARING
BTM	ВОТТОМ
CIP	CAST IN PLACE
CL	CENTERLINE
CLG	CEILING
CT	CERAMIC TILE
CLR	CLEAR
COL	COLUMN
CPT	CARPET
CONC	CONCRETE
CMU	CONCRETE MASONRY UNIT
CONT	CONTINUOUS
CJ	CONTROL JOINT
DF	DRINKING FOUNTAIN
DIA	DIAMETER
DS	DOWNSPOUT
DTL	DETAIL
DW	DISHWASHER
ELEV	ELEVATION
EQ	EQUAL
EX	EXISTING
FD	FLOOR DRAIN
FDN	FOUNDATION
FE	FIRE EXTINGUISHER

FIELD VERIFY GAUGE GYPSUM BOARD GENERAL CONTRACTOR HOLLOW METAL HEIGHT HORIZONTAL MAXIMUM

FINISH FLOOR

FOOD SERVICE EQUIPMENT

FINISH(ED)

MECHANICAL MASONRY OPENING MOUNTED METAL NOT IN CONTRACT NOT TO SCALE

PEMB PRE-ENGINEERED METAL BUILDING

ON CENTER

PAINTED QUARRY TILE ROOF DRAIN REFRIGERATOR REQUIRED ROUGH OPENING SIMILAR SHEET METAL

SPECIFICATION STAINLESS STEEL SQUARE STEEL TOP OF

UNIFORM FEDERAL ACCESSIBILITY STD. WEATHER RESISTIVE BARRIER WELDED WIRE FABRIC

### ABBREVIATIONS

ACCESSIBILITY GUIDELINES	
ABOVE FINISH FLOOR	This drawing is the architect's instrument of
ALUMINUM	service for use solely with respect to this project. RDA Group Architects is the auti
ACOUSTIC TILE CEILING	of this document and shall retain all copyri and other reserved rights, unless otherwis
BLOCKING	agreed upon in writing.
BETWEEN	0.11
BEARING	
ВОТТОМ	
CAST IN PLACE	
CENTERLINE	
CEILING	0,
CERAMIC TILE	
CLEAR	
COLUMN	

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RDA

**ARCHITECTS** 

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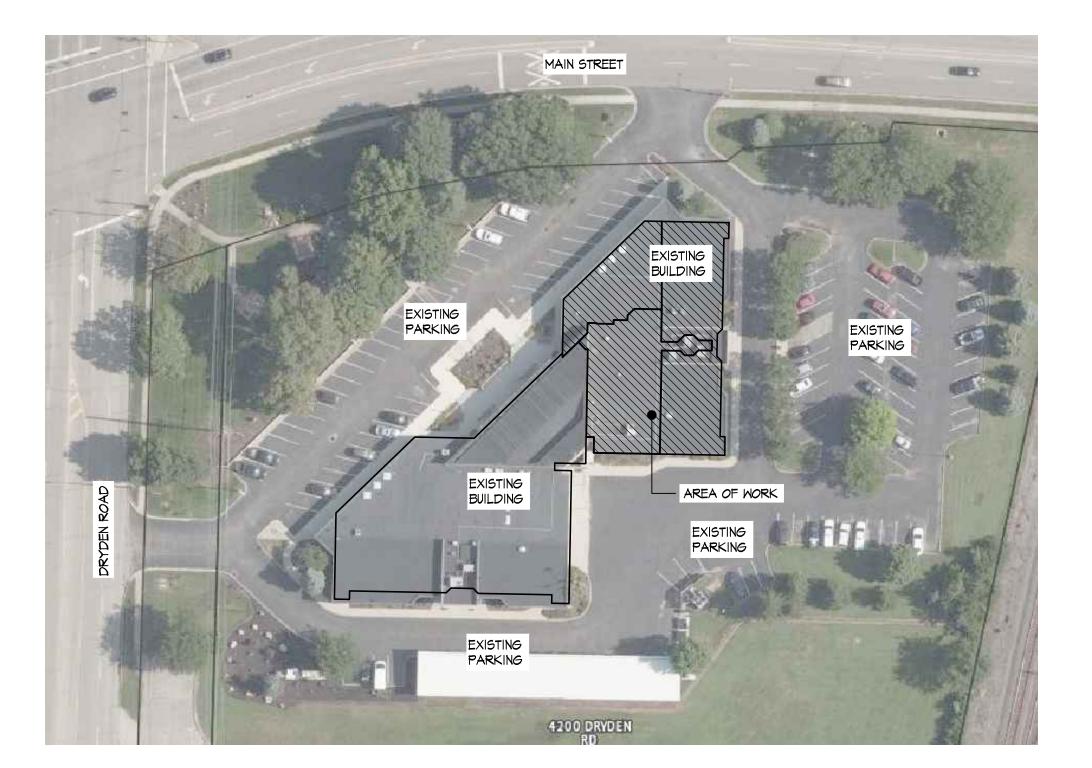
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Date March 29, 2023

Sheet Title PROJECT INFORMATION SITE PLAN

Sheet Number








THE PLANS AND SPECIFICATIONS ARE INTENDED TO DEPICT THE GENERAL SCOPE, LAYOUT AND QUALITY OF MORKMANSHIP REQUIRED. THE DOCUMENTS ARE NOT AN 'INSTRUCTION MANUAL' TO EXECUTE THE WORK NOR ARE THEY INTENDED TO SHOW OR DESCRIBE IN DETAIL EVERY ITEM NECESSARY FOR THE PROPER INSTALLATION OF THE WORK. THE MEANS AND METHODS REQUIRED TO EXECUTE THE WORK DESCRIBED IS THE SOLE RESPONSIBILITY OF THE CONTRACTOR. THE CONTRACTOR SHALL INCLUDE THE ANCILLARY WORK REQUIRED, WHETHER EXPLICITLY STATED OR NOT, FOR THE PROPER COMPLETION OF THE WORK AS INTENDED THE CONTRACTOR IS REQUIRED TO MEET OR EXCEED BUILDING CODE REQUIREMENTS, APPLICABLE INDUSTRY STANDARDS, ASTM STANDARDS, AND/OR MANUFACTURER INSTALLATION REQUIREMENTS AS THEY RELATE TO

THE PLANS AND SPECIFICATIONS REPRESENT A SINGLE COMPLETE DESIGN PACKAGE INDICATING THE INTENDED SCOPE OF THE PROJECT IN ITS ENTIRETY. AS SUCH, THE PROJECT IS STRUCTURED TO BE AWARDED TO A SINGLE PRIME CONTRACTOR. THE DOCUMENTS DO NOT DELINEATE BID PACKAGES OR ASSIGN RESPONSIBILITIES TO ANY SUBSEQUENT SUBCONTRACTORS, DICTATE CONSTRUCTION SEQUENCING, NOR PROVIDE COORDINATION BETWEEN ANY 'TRADES'. SUCH ACTIVITIES ARE THE RESPONSIBILITY OF THE HOLDER OF THE CONSTRUCTION CONTRACT. IN THE EVENT OF A DISCREPANCY WITHIN THE DRAWINGS OR BETWEEN THE DRAWINGS AND THE SPECIFICATIONS, THE MORE STRINGENT REQUIREMENT REPRESENTED IN THE DOCUMENTS

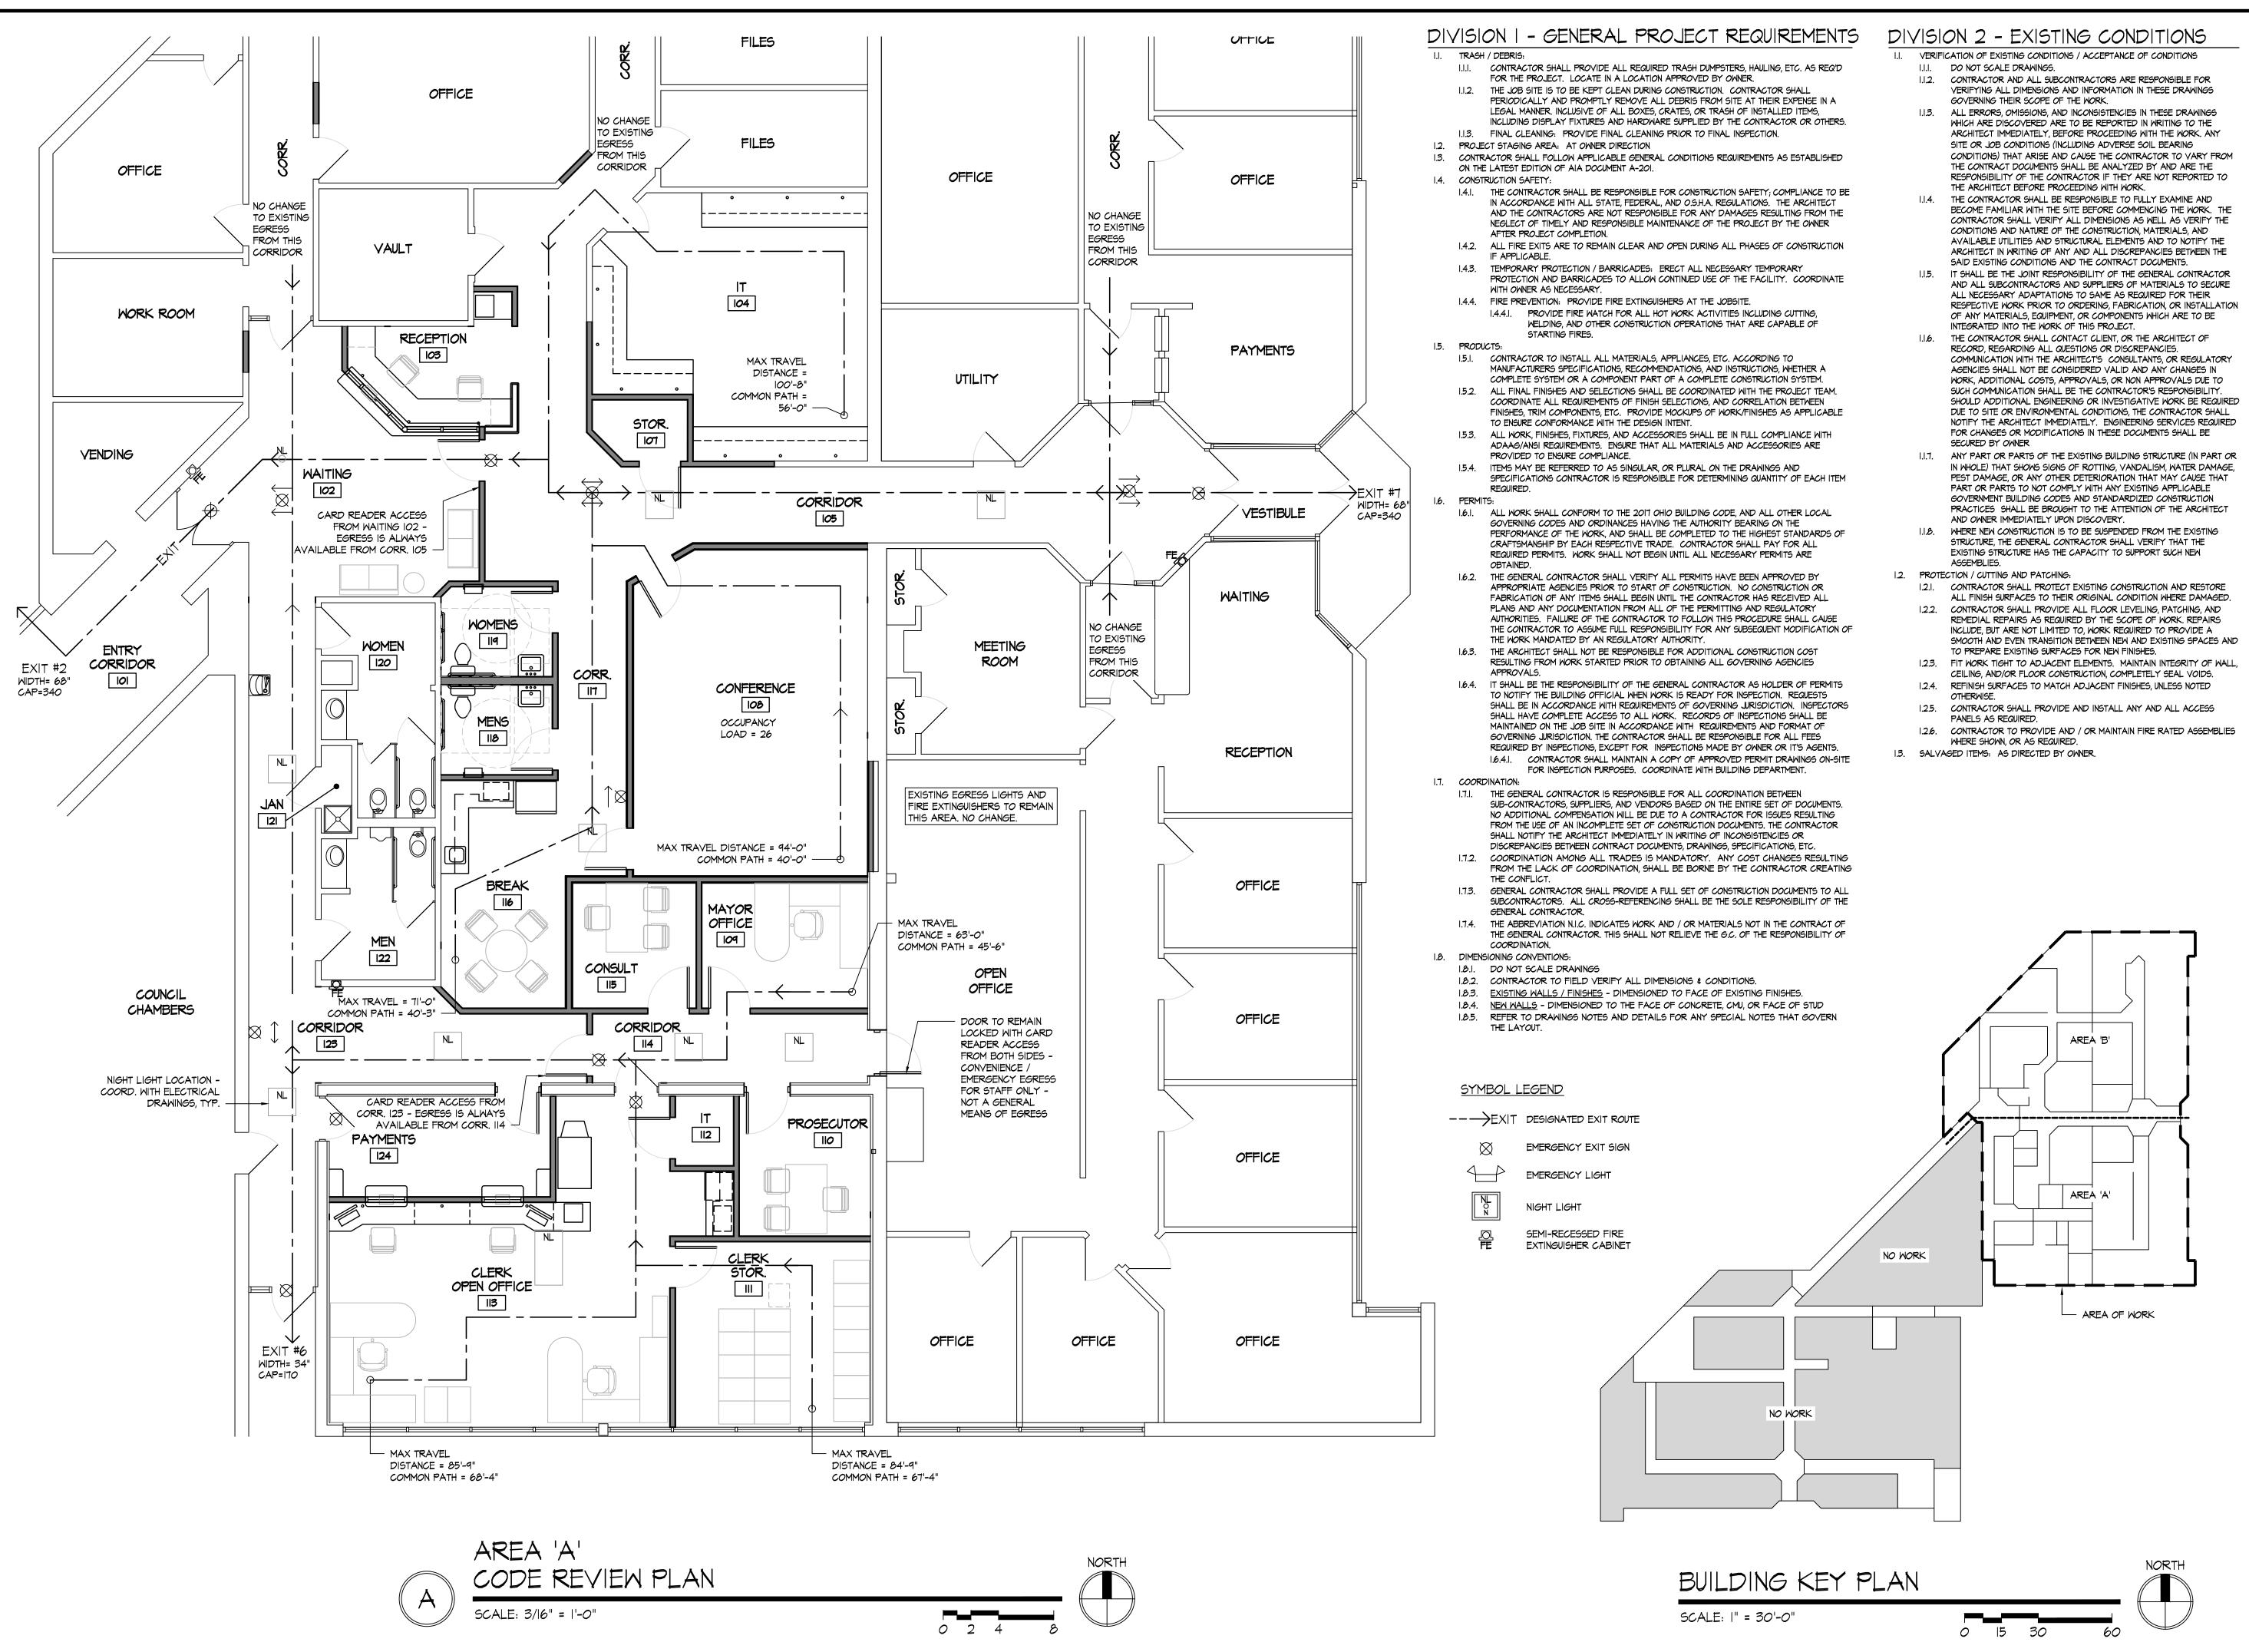

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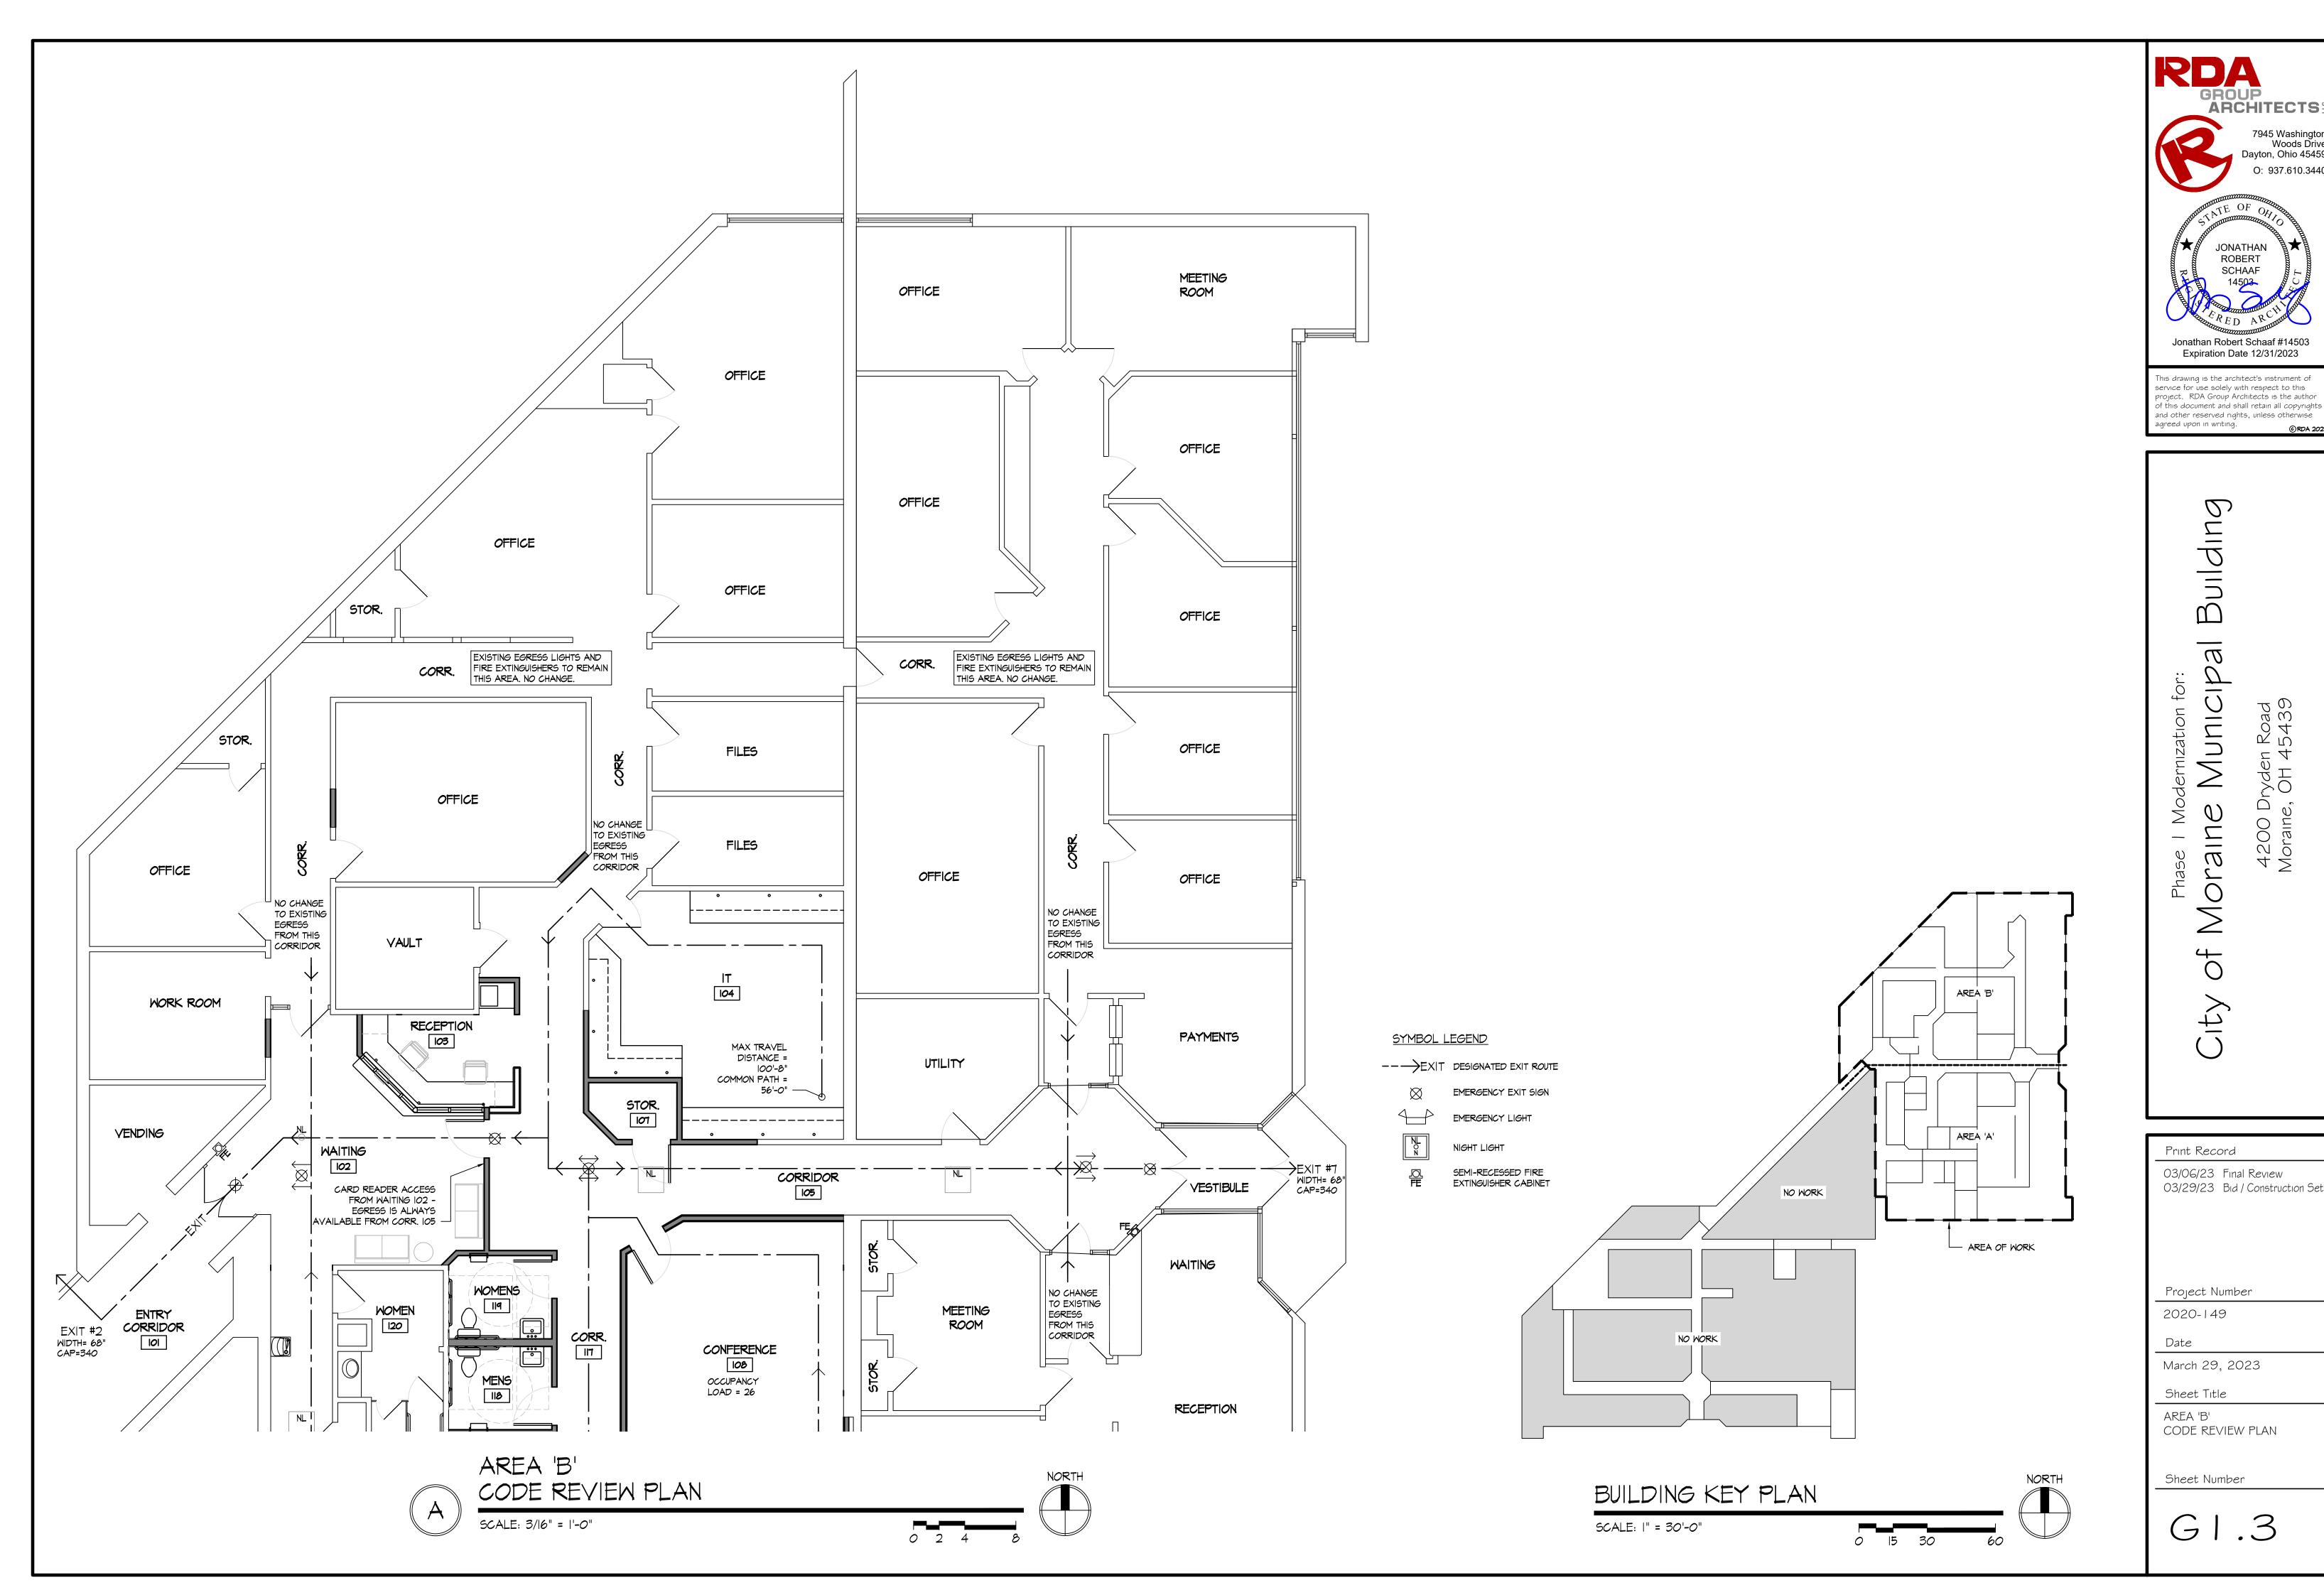
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AREA 'A' CODE REVIEW PLAN

Sheet Number

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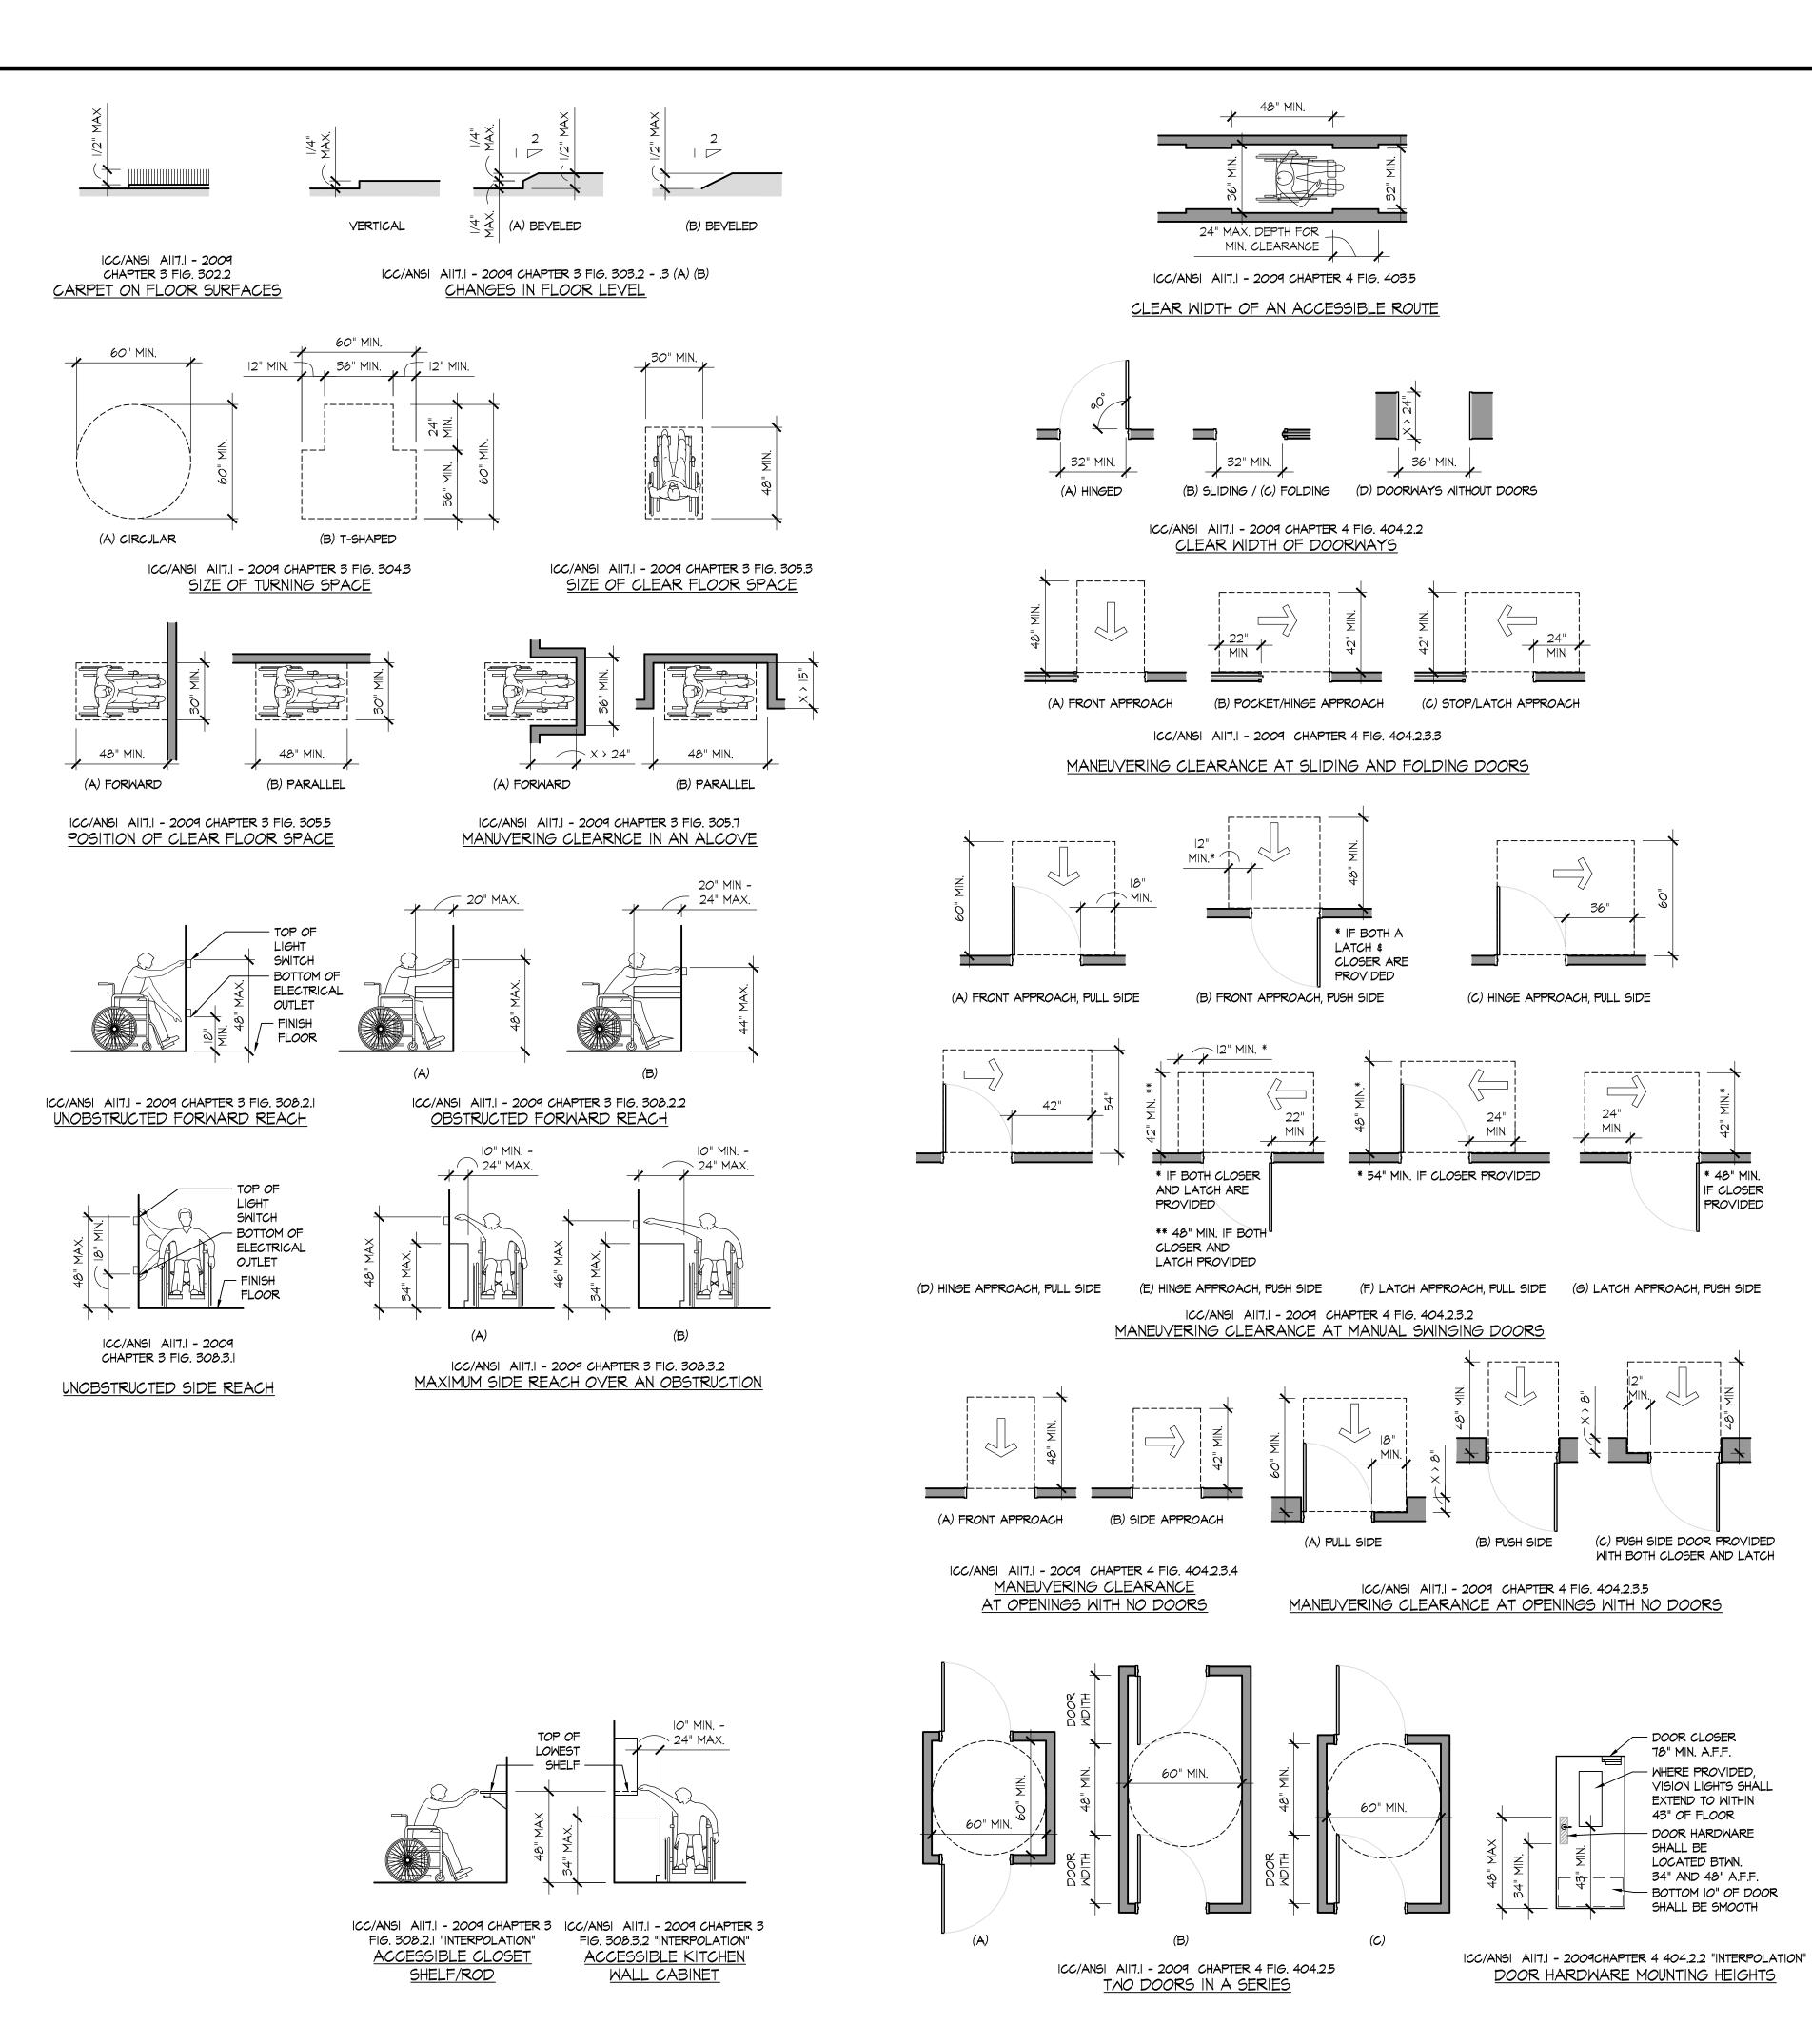
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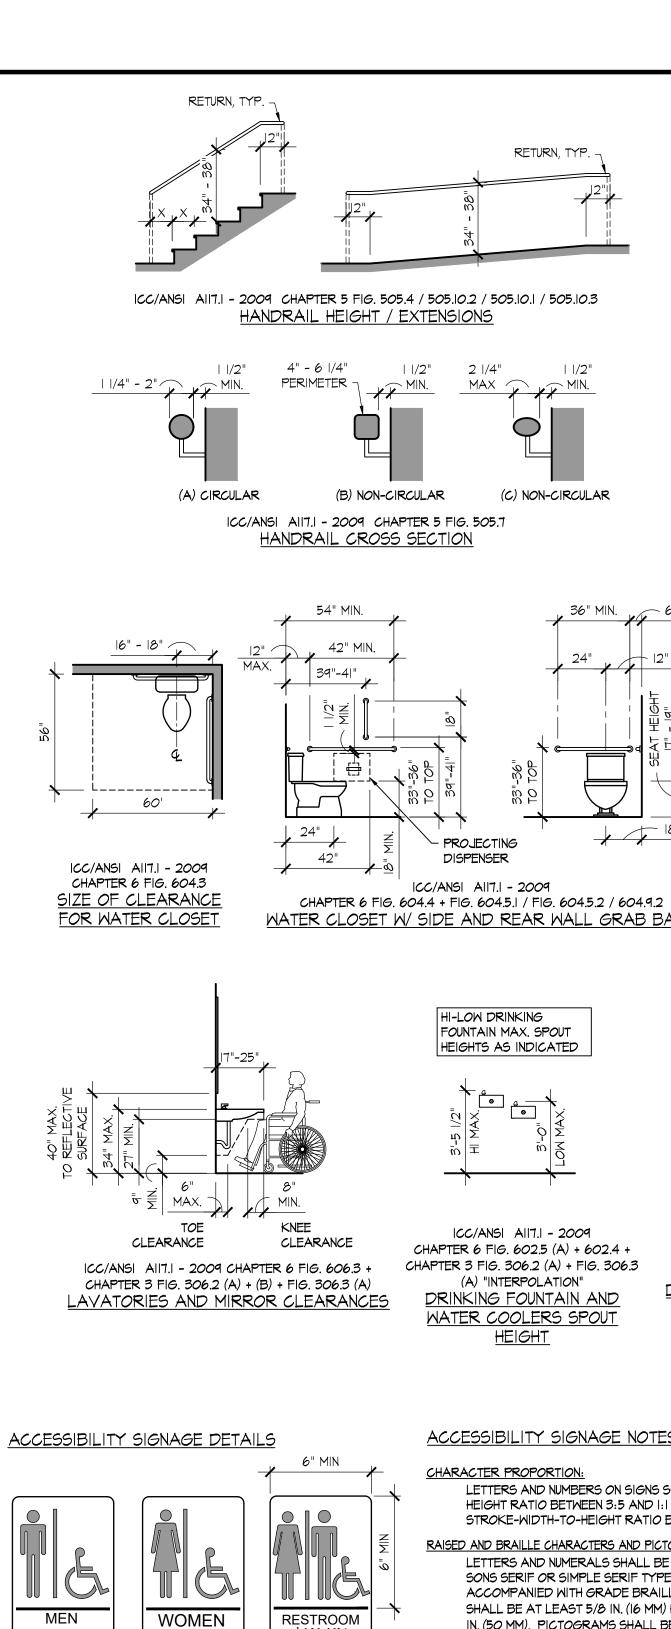
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4 2 7 3 3

- ACCESSIBLE SIGNAGE

PER OBC III AND

ICC A117.1-2009

SECTION 703

INTERNATIONAL SYMBOL OF ACCESSIBILITY

TOILET ROOM WALL MOUNTED SIGN


TOILET ROOM DOOR


MOUNTED SIGN

1277

TACTILE EXIT WALL

MOUNTED SIGN

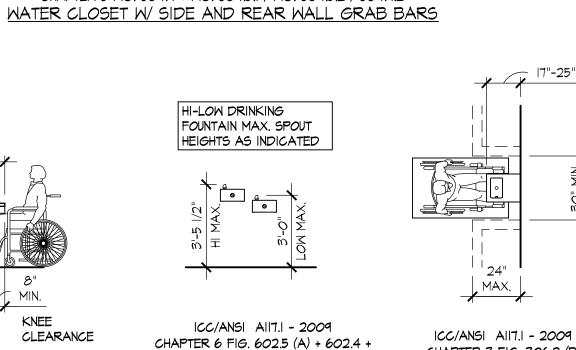

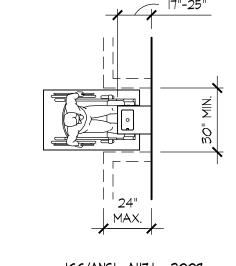

CHAPTER 3 FIG. 306.2 (B)

"INTERPOLATION"

DRINKING FOUNTAIN AND

WATER COOLERS

MATER COOLERS SPOUT CLEAR FLOOR SPACE <u>HEIGHT</u>



(C) NON-CIRCULAR

- PROJECTING DISPENSER

ICC/ANSI AII7.I - 2009

### CHARACTER PROPORTION:

(A) "INTERPOLATION"

DRINKING FOUNTAIN AND

LETTERS AND NUMBERS ON SIGNS SHALL HAVE A WIDTH-TO HEIGHT RATIO BETWEEN 3:5 AND I:1 AND A STROKE-WIDTH-TO-HEIGHT RATIO BETWEEN 1:5 AND 1:10.

RAISED AND BRAILLE CHARACTERS AND PICTORIAL SYMBOL SIGNS (PICTOGRAMS): LETTERS AND NUMERALS SHALL BE RAISED 1/32 IN., UPPER CASE, SONS SERIF OR SIMPLE SERIF TYPE AND SHALL BE ACCOMPANIED WITH GRADE BRAILLE. RAISED CHARACTERS SHALL BE AT LEAST 5/8 IN. (16 MM) HIGH, BUT NO HIGHER THAN 2 IN. (50 MM). PICTOGRAMS SHALL BE ACCOMPANIED BY THE EQUIVALENT VERBAL DESCRIPTION PLACED DIRECTLY BELOW THE PICTOGRAM. THE BORDER DIMENSION OF THE PICTOGRAM SHALL BE 6 IN. (152 MM) MINIMUM OF HEIGHT.

### FINISH AND CONTRAST:

THE CHARACTERS AND BACKGROUND OF SIGNS SHALL BE EGGSHELL, MATTE, OR OTHER NON-GLARE FINISH. CHARACTERS AND SYMBOLS SHALL CONTRAST WITH THEIR BACKGROUND WITH EITHER LIGHT CHARACTERS ON A DARK BACKGROUND OR DARK CHARACTERS ON A LIGHT BACKGROUND. MOUNTING LOCATION AND HEIGHT:

WHERE PERMANENT IDENTIFICATION IS PROVIDED FOR ROOMS AND SPACES, SIGNS SHALL BE INSTALLED ON THE WALL ADJACENT TO THE LATCH SIDE OF THE DOOR. WHERE THERE IS NO WALL SPACE TO THE LATCH SIDE OF THE DOOR, INCLUDING AT DOUBLE LEAF DOORS, SIGNS SHALL BE PLACED ON THE NEAREST ADJACENT WALL. MOUNTING LOCATION FOR SUCH SIGNAGE SHALL BE SO THAT A PERSON MAY APPROACH WITHIN 3 IN. (76 MM) OF SIGNAGE WITHOUT ENCOUNTERING PROTRUDING OBJECTS OR STANDING WITHIN THE SWING OF THE DOOR. MOUNTING HEIGHT

### CENTERLINE OF THE SIGN. SYMBOLS OF ACCESSIBILITY:

FACILITIES AND ELEMENTS REQUIRED TO BE IDENTIFIED AS ACCESSIBLE BY SECTION 4.1 OF THE A.D.A.A.G. SHALL USE THE INTERNATIONAL SYMBOL OF ACCESSIBILITY.

SHALL BE 60 IN. (1525 MM) ABOVE THE FINISH FLOOR TO THE



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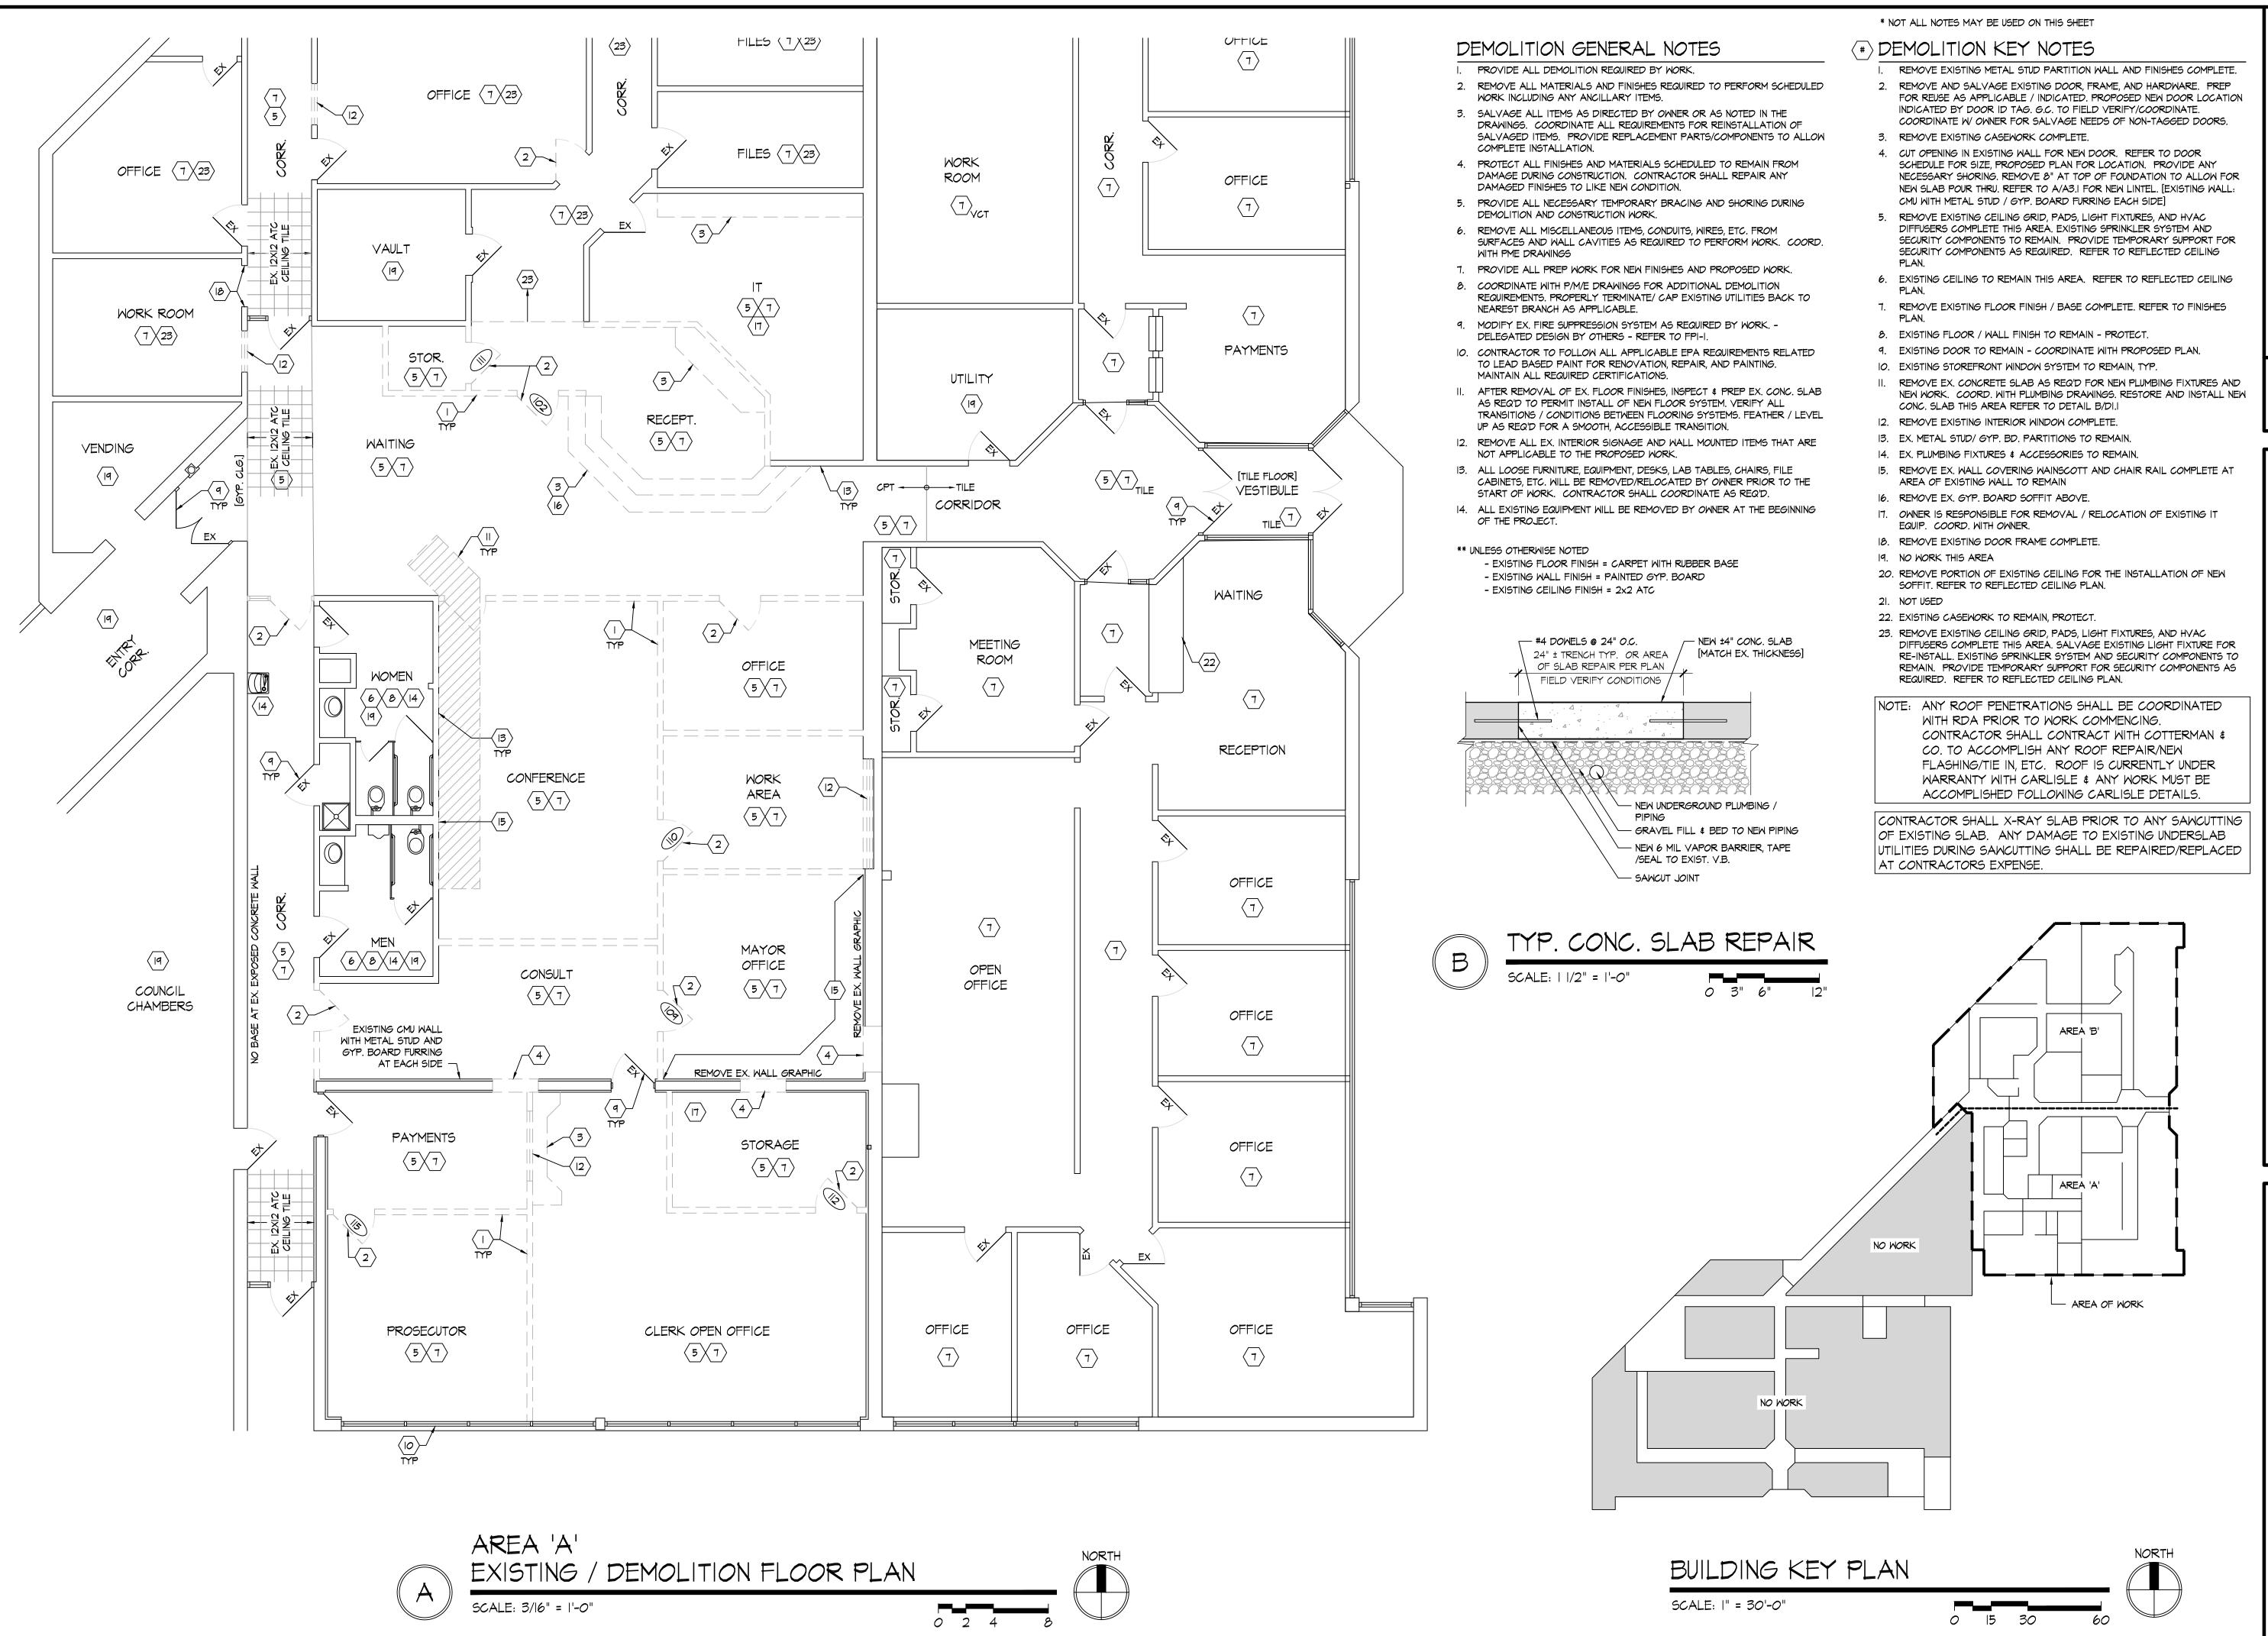
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ACCESSIBILITY GUIDELINES

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AREA 'A' EXISTING/DEMOLITION FLOOR PLAN

### EXISTING BUILDING CONSTRUCTION

PRIMARY STRUCTURE: MASONRY BEARING / STEEL FRAME EXTERIOR WALLS: MASONRY WITH STONE PANEL VENEER EXTERIOR WINDOW SYSTEMS: STOREFRONT WINDOWS FLOOR: CONCRETE SLAB ON GRADE THIS AREA

### HAZARDOUS MATERIALS NOTES

HAZARDOUS MATERIALS MAY EXIST ON THIS PROJECT. IF ANY WORK PERSON ENCOUNTERS ANY MATERIAL WHICH THEY SUSPECT MAY BE HAZARDOUS OR TOXIC, THEY SHALL IMMEDIATELY ADVISE THE OWNER. THE CONTRACTOR SHALL TAKE IMMEDIATE AND APPROPRIATE ACTION TO PROTECT THE BUILDING USERS AND WORKERS IN ACCORDANCE W/ FEDERAL, STATE, AND LOCAL LAWS, CODES AND REGULATIONS. THE ARCHITECT AND ARCHITECT'S CONSULTANTS SHALL HAVE NO RESPONSIBILITY FOR THE DISCOVERY, PRESENCE, HANDLING, REMOVAL OR DISPOSAL OF OR EXPOSURE OF PERSONS TO HAZARDOUS MATERIALS IN ANY FORM AT THE PROJECTS SITE, INCLUDING BUT NOT LIMITED TO ASBESTOS, ASBESTOS PRODUCTS, POLYCHLORINATED BIPHENYL (PCB) OR OTHER TOXIC SUBSTANCES.

- I. THE CONTRACTOR IS HEREBY ADVISED THAT RDA GROUP ARCHITECTS, LLC. IS NOT A DESIGN PROFESSIONAL IN THE DETERMINATION OF THE PRESENCE OF HAZARDOUS MATERIALS, NOR IS RDA A DESIGN PROFESSIONAL INVOLVED IN MAKING RECOMMENDATIONS REGARDING THE TESTING, REMOVAL, ENCAPSULATION OR OTHER CORRECTIVE MEASURES PERTAINING TO HAZARDOUS MATERIALS.
- 2. IF THE WORK WHICH IS TO BE PERFORMED UNDER THE CONTRACT INTERFACES IN ANY WAY W/ THE EXISTING COMPONENTS WHICH CONTAIN HAZARDOUS MATERIALS, IT IS THE CONTRACTORS RESPONSIBILITY TO CONTACT THE OWNER'S ENVIRONMENTAL CONSULTANT REGARDING THE PROPER MEANS & METHODS TO BE UTILIZED IN DEALING W/ HAZARDOUS MATERIALS.
- 3. BY EXECUTION OF THE CONTRACT FOR CONSTRUCTION, THE CONTRACTOR HEREBY AGREES TO BRING NO CLAIM FOR NEGLIGENCE, BREACH OF CONTRACT, INDEMNITY OR OTHERWISE AGAINST THE ARCHITECT, HIS PRINCIPLES, EMPLOYEES, AGENTS OR CONSULTANTS IF SUCH A CLAIM IN ANY WAY WOULD INVOLVE THE INVESTIGATION OF OR REMEDIAL WORK RELATED TO HAZARDOUS MATERIALS IN THE PROJECT.
- 4. BY EXECUTION OF THE CONTRACT FOR CONSTRUCTION, THE CONTRACTOR FURTHER AGREES TO DEFEND, INDEMNIFY AND HOLD THE ARCHITECT, HIS PRINCIPLES, EMPLOYEES, AGENTS OR CONSULTANTS HARMLESS FROM ANY SUCH ASBESTOS OR OTHER HAZARDOUS MATERIALS RELATED CLAIMS THAT MAY BE BROUGHT BY THE CONTRACTOR'S SUBCONTRACTORS, SUPPLIERS OR OTHER THIRD PARTIES WHO MAY BE ACTING UNDER THE DIRECTION OF THE CONTRACTOR PURSUANT TO THIS PROJECT.


\* NOT ALL NOTES MAY BE USED ON THIS SHEET

### (#) DEMOLITION KEY NOTES

- REMOVE EXISTING METAL STUD PARTITION WALL AND FINISHES COMPLETE. REMOVE AND SALVAGE EXISTING DOOR, FRAME, AND HARDWARE. PREP
  - FOR REUSE AS APPLICABLE / INDICATED. PROPOSED NEW DOOR LOCATION INDICATED BY DOOR ID TAG. G.C. TO FIELD VERIFY/COORDINATE. COORDINATE W/ OWNER FOR SALVAGE NEEDS OF NON-TAGGED DOORS.
  - 3. REMOVE EXISTING CASEWORK COMPLETE.
  - 4. CUT OPENING IN EXISTING WALL FOR NEW DOOR. REFER TO DOOR SCHEDULE FOR SIZE, PROPOSED PLAN FOR LOCATION. PROVIDE ANY NECESSARY SHORING. REMOVE 8" AT TOP OF FOUNDATION TO ALLOW FOR NEW SLAB POUR THRU. REFER TO A/A3.1 FOR NEW LINTEL. [EXISTING WALL: CMU WITH METAL STUD / GYP. BOARD FURRING EACH SIDE]
  - REMOVE EXISTING CEILING GRID, PADS, LIGHT FIXTURES, AND HVAC DIFFUSERS COMPLETE THIS AREA. EXISTING SPRINKLER SYSTEM AND SECURITY COMPONENTS TO REMAIN. PROVIDE TEMPORARY SUPPORT FOR SECURITY COMPONENTS AS REQUIRED. REFER TO REFLECTED CEILING
  - 6. EXISTING CEILING TO REMAIN THIS AREA. REFER TO REFLECTED CEILING
  - REMOVE EXISTING FLOOR FINISH / BASE COMPLETE. REFER TO FINISHES
  - 8. EXISTING FLOOR / WALL FINISH TO REMAIN PROTECT.
  - 9. EXISTING DOOR TO REMAIN COORDINATE WITH PROPOSED PLAN.
  - IO. EXISTING STOREFRONT WINDOW SYSTEM TO REMAIN, TYP.
  - II. REMOVE EX. CONCRETE SLAB AS REQ'D FOR NEW PLUMBING FIXTURES AND NEW WORK. COORD. WITH PLUMBING DRAWINGS. RESTORE AND INSTALL NEW CONC. SLAB THIS AREA REFER TO DETAIL B/DI.I
  - 12. REMOVE EXISTING INTERIOR WINDOW COMPLETE.
  - 13. EX. METAL STUD/ GYP. BD. PARTITIONS TO REMAIN.
  - 14. EX. PLUMBING FIXTURES & ACCESSORIES TO REMAIN. 15. REMOVE EX. WALL COVERING WAINSCOTT AND CHAIR RAIL COMPLETE AT
  - AREA OF EXISTING WALL TO REMAIN
  - 16. REMOVE EX. GYP. BOARD SOFFIT ABOVE. 17. OWNER IS RESPONSIBLE FOR REMOVAL / RELOCATION OF EXISTING IT

EQUIP. COORD. WITH OWNER.

- 18. REMOVE EXISTING DOOR FRAME COMPLETE. 19. NO WORK THIS AREA
- 20. REMOVE PORTION OF EXISTING CEILING FOR THE INSTALLATION OF NEW SOFFIT. REFER TO REFLECTED CEILING PLAN.
- 21. NOT USED
- 22. EXISTING CASEWORK TO REMAIN, PROTECT.
- 23. REMOVE EXISTING CEILING GRID, PADS, LIGHT FIXTURES, AND HVAC DIFFUSERS COMPLETE THIS AREA. SALVAGE EXISTING LIGHT FIXTURE FOR RE-INSTALL. EXISTING SPRINKLER SYSTEM AND SECURITY COMPONENTS TO REMAIN. PROVIDE TEMPORARY SUPPORT FOR SECURITY COMPONENTS AS

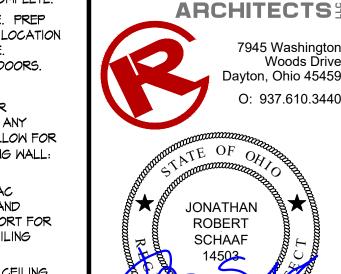

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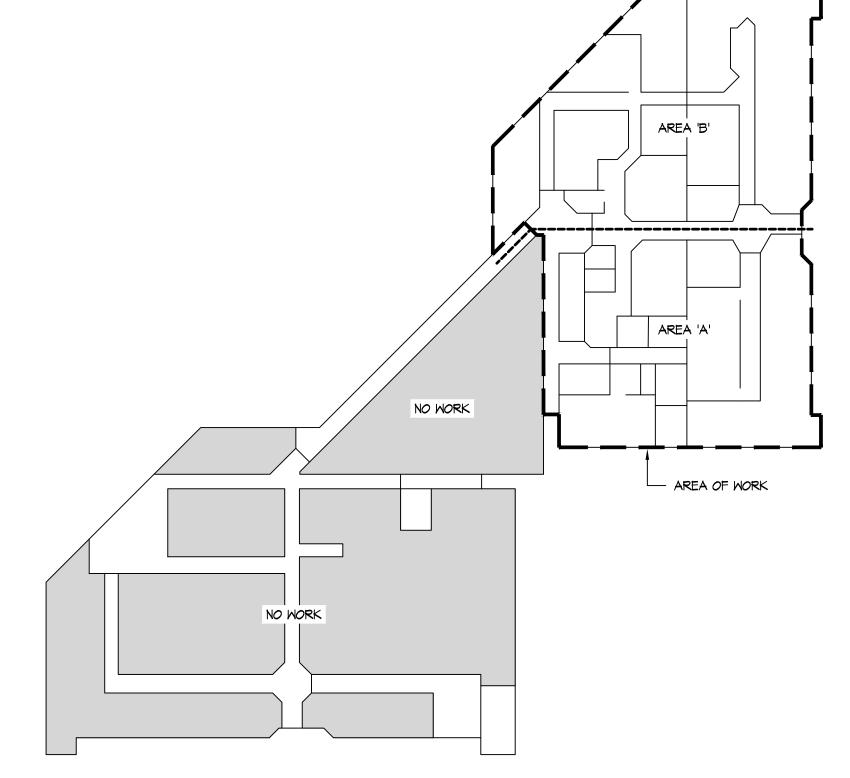
2020-149

March 29, 2023

Sheet Title AREA 'B'


FLOOR PLAN Sheet Number

EXISTING/DEMOLITION



BUILDING KEY PLAN

SCALE: |" = 30'-0"

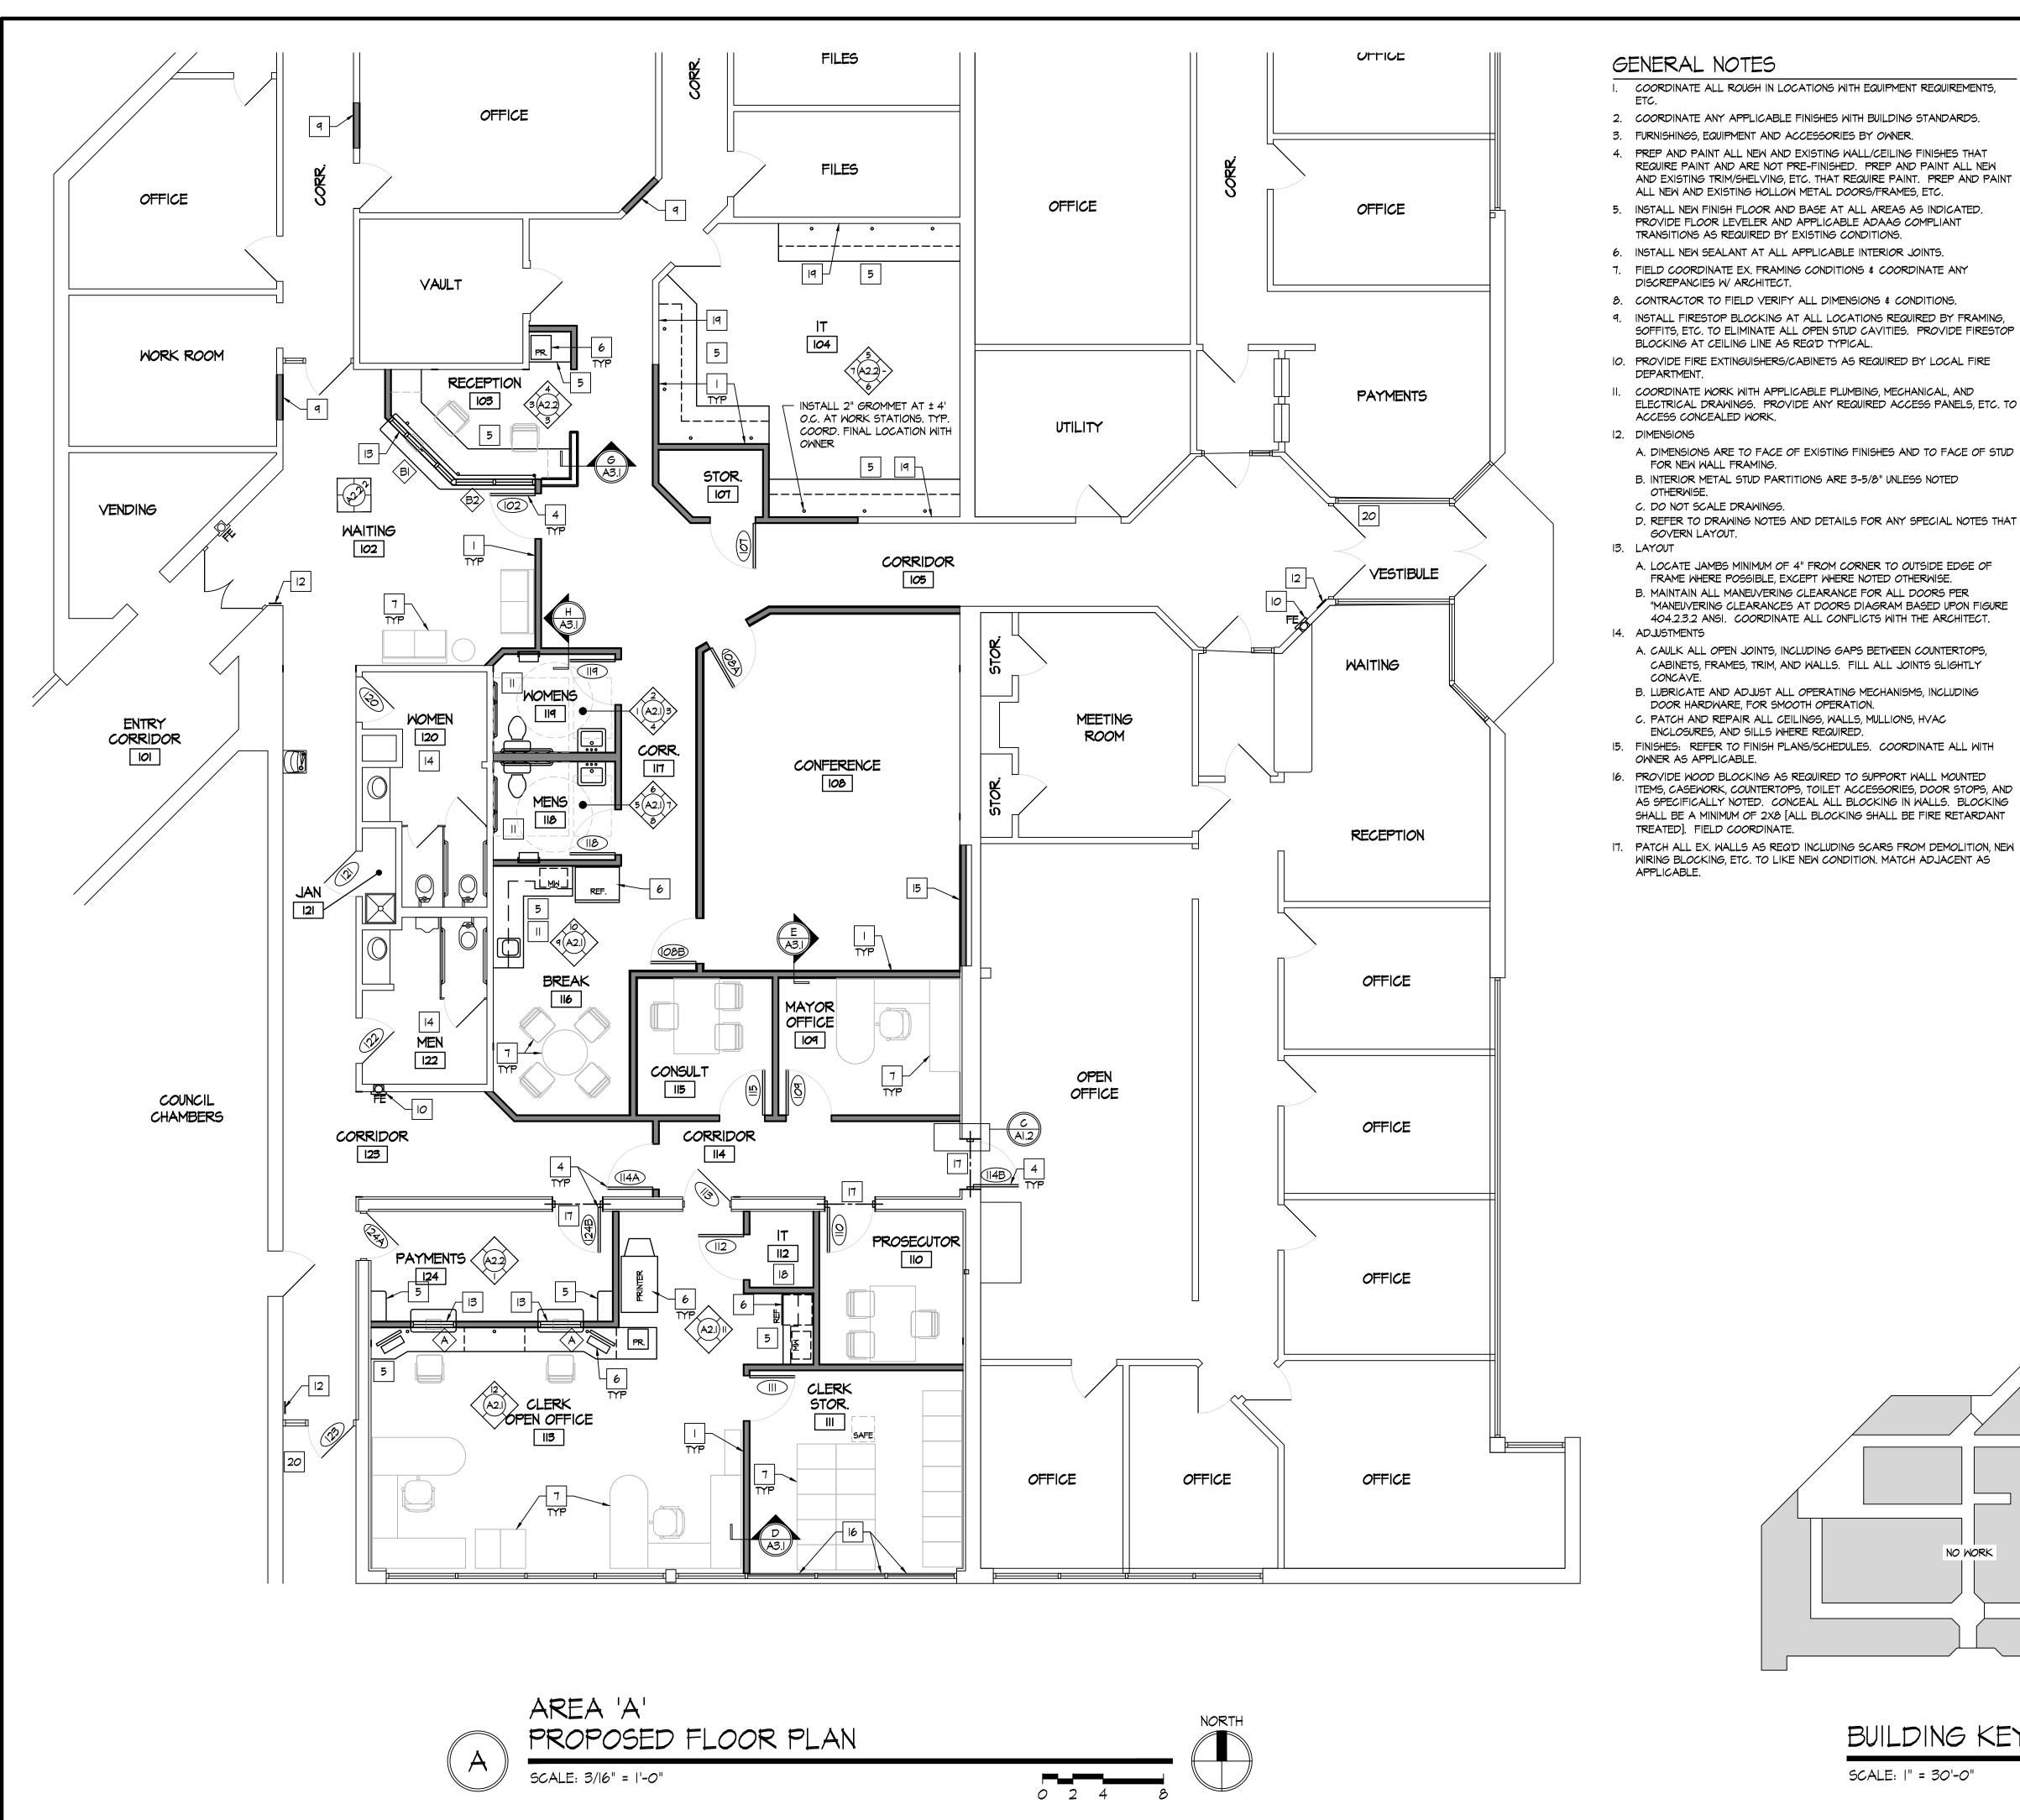

### GENERAL NOTES

- I. COORDINATE ALL ROUGH IN LOCATIONS WITH EQUIPMENT REQUIREMENTS,
- 2. COORDINATE ANY APPLICABLE FINISHES WITH BUILDING STANDARDS.
- 3. FURNISHINGS, EQUIPMENT AND ACCESSORIES BY OWNER.
- 4. PREP AND PAINT ALL NEW AND EXISTING WALL/CEILING FINISHES THAT REQUIRE PAINT AND ARE NOT PRE-FINISHED. PREP AND PAINT ALL NEW AND EXISTING TRIM/SHELVING, ETC. THAT REQUIRE PAINT. PREP AND PAINT ALL NEW AND EXISTING HOLLOW METAL DOORS/FRAMES, ETC.
- 5. INSTALL NEW FINISH FLOOR AND BASE AT ALL AREAS AS INDICATED. PROVIDE FLOOR LEVELER AND APPLICABLE ADAAG COMPLIANT
- 6. INSTALL NEW SEALANT AT ALL APPLICABLE INTERIOR JOINTS.
- 7. FIELD COORDINATE EX. FRAMING CONDITIONS \$ COORDINATE ANY
- DISCREPANCIES W/ ARCHITECT.
- 8. CONTRACTOR TO FIELD VERIFY ALL DIMENSIONS & CONDITIONS. 9. INSTALL FIRESTOP BLOCKING AT ALL LOCATIONS REQUIRED BY FRAMING, SOFFITS, ETC. TO ELIMINATE ALL OPEN STUD CAVITIES. PROVIDE FIRESTOP BLOCKING AT CEILING LINE AS REQ'D TYPICAL.
- 10. PROVIDE FIRE EXTINGUISHERS/CABINETS AS REQUIRED BY LOCAL FIRE DEPARTMENT.
- ELECTRICAL DRAWINGS. PROVIDE ANY REQUIRED ACCESS PANELS, ETC. TO ACCESS CONCEALED WORK.
- FOR NEW WALL FRAMING. B. INTERIOR METAL STUD PARTITIONS ARE 3-5/8" UNLESS NOTED
- OTHERWISE. C. DO NOT SCALE DRAWINGS.
- D. REFER TO DRAWING NOTES AND DETAILS FOR ANY SPECIAL NOTES THAT GOVERN LAYOUT.
- 13. LAYOUT A. LOCATE JAMBS MINIMUM OF 4" FROM CORNER TO OUTSIDE EDGE OF
- FRAME WHERE POSSIBLE, EXCEPT WHERE NOTED OTHERWISE. B. MAINTAIN ALL MANEUVERING CLEARANCE FOR ALL DOORS PER "MANEUVERING CLEARANCES AT DOORS DIAGRAM BASED UPON FIGURE 404.2.3.2 ANSI. COORDINATE ALL CONFLICTS WITH THE ARCHITECT.
- A. CAULK ALL OPEN JOINTS, INCLUDING GAPS BETWEEN COUNTERTOPS, CABINETS, FRAMES, TRIM, AND WALLS. FILL ALL JOINTS SLIGHTLY
- CONCAVE. B. LUBRICATE AND ADJUST ALL OPERATING MECHANISMS, INCLUDING
- DOOR HARDWARE, FOR SMOOTH OPERATION. C. PATCH AND REPAIR ALL CEILINGS, WALLS, MULLIONS, HVAC
- ENCLOSURES, AND SILLS WHERE REQUIRED.
- 15. FINISHES: REFER TO FINISH PLANS/SCHEDULES. COORDINATE ALL WITH OWNER AS APPLICABLE.
- 16. PROVIDE WOOD BLOCKING AS REQUIRED TO SUPPORT WALL MOUNTED ITEMS, CASEWORK, COUNTERTOPS, TOILET ACCESSORIES, DOOR STOPS, AND AS SPECIFICALLY NOTED. CONCEAL ALL BLOCKING IN WALLS. BLOCKING SHALL BE A MINIMUM OF 2X8 [ALL BLOCKING SHALL BE FIRE RETARDANT TREATED]. FIELD COORDINATE.
- 17. PATCH ALL EX. WALLS AS REQ'D INCLUDING SCARS FROM DEMOLITION, NEW WIRING BLOCKING, ETC. TO LIKE NEW CONDITION. MATCH ADJACENT AS APPLICABLE.

- NOT USED
- 3. NOT USED 4. NEW / SALVAGED DOOR, FRAME, AND HARDWARE, TYP. REFER TO DOOR
- SCHEDULE. 5. NEW CASEWORK, REFER TO INTERIOR ELEVATIONS / DETAILS. PROVIDE FRT
- 6. EQUIPMENT BY OWNER, TYP. (PROVIDE BLOCKING FOR WALL MOUNTED ITEMS,
- 7. FURNISHINGS BY OWNER, TYP.
- 8. NOT USED
- 9. INFILL OPENING IN METAL STUD WALL. MATCH IN LIKE KIND / FINISH FLUSH TO PROVIDE A UNIFORM FINISH.
- 10. INSTALL NEW SEMI RECESSED FIRE EXTINGUISHER CABINET. COORDINATE FINAL LOCATION WITH FIRE DEPARTMENT AS APPLICABLE.
- NEW PLUMBING FIXTURES AND ACCESSORIES. REFER TO INTERIOR ELEVATIONS. EXTEND SUPPLY/SANITARY PIPING FROM EXISTING. REFER TO P/M/E DRAWINGS
- 12. INSTALL TACTILE EXIT SIGN ADJACENT TO ALL EGRESS DOORS, TYP.
- 13. NEW BALLISTIC INTERIOR TRANSACTION WINDOW, INSTALL NEW TRANSACTION COUNTERTOP. REFER TO WINDOW SCHEDULE AND INTERIOR ELEVATIONS.
- 14. EXISTING TOILET ROOM PLUMBING FIXTURES & ACCESSORIES TO REMAIN. 15. INFILL OPENING W/ 3 5/8" METAL STUDS AT 16" O.C., 3" SOUND BATT
- INSULATION, AND [2] LAYERS OF 5/8" NOISE REDUCING GYPSUM BOARD. 16. INSTALL 3M BLACKOUT FILM ON INTERIOR FACE OF EXISTING GLAZING
- SYSTEM. REFER TO B/AI.2. 17. INSTALL NEW LINTEL AT NEW DOOR OPENING. REFER TO DETAIL A/A3.I. -PROVIDE GYP. BOARD RETURNS AT NEW H.M. DOOR FRAME.
- 18. PROVIDE 3/4" THICK 4'x4' FRT PLYWOOD BACK BOARD FOR IT EQUIPMENT. COORD. MOUNTING LOCATION WITH OWNER.
- 19. CUT / PATCH EXIST GYP. BOARD TO ALLOW FOR INSTALL OF FRT BLOCKING FOR WALL MOUNTED SHELVING AT EXISTING WALLS, TYP.
- 20. CARD READER ACCESS TO BE PROVIDED AT EXISTING DOOR. COORD. WITH OWNER'S SECURITY CONSULTANT [ISM].

### # NEW CONSTRUCTION KEY NOTES

NEW METAL STUD FRAME WALL W/ GYPSUM BOARD FINISHES. REFER TO WALL TYPES ON SHEET AI.3.



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2020-149


Date March 29, 2023

Sheet Title

AREA 'A' PROPOSED FLOOR PLAN


Sheet Number

A1.

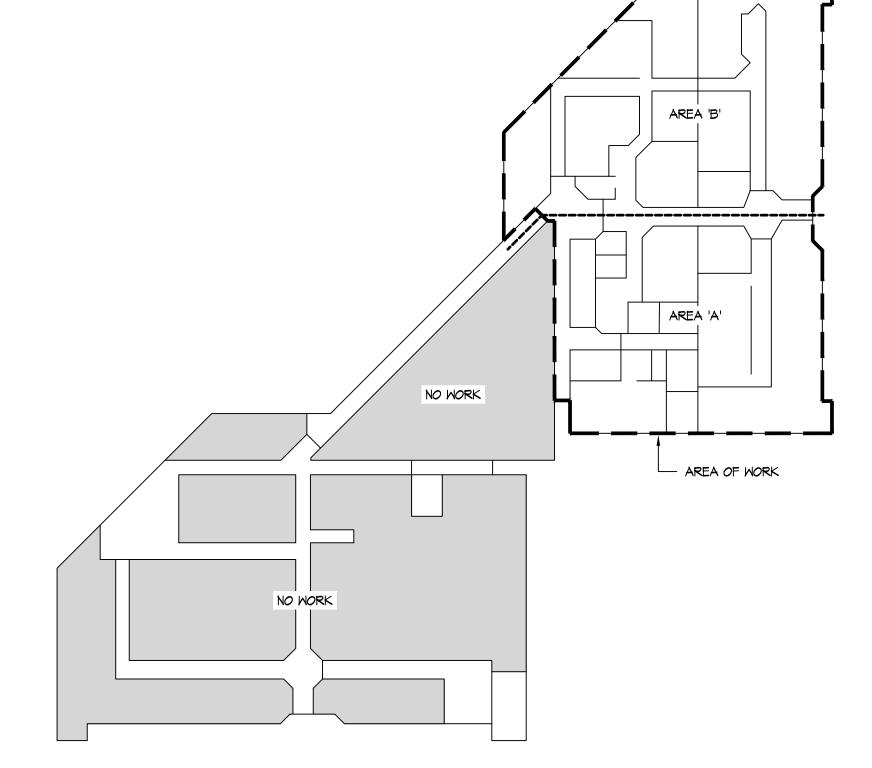

BUILDING KEY PLAN

SCALE: |" = 30'-0"

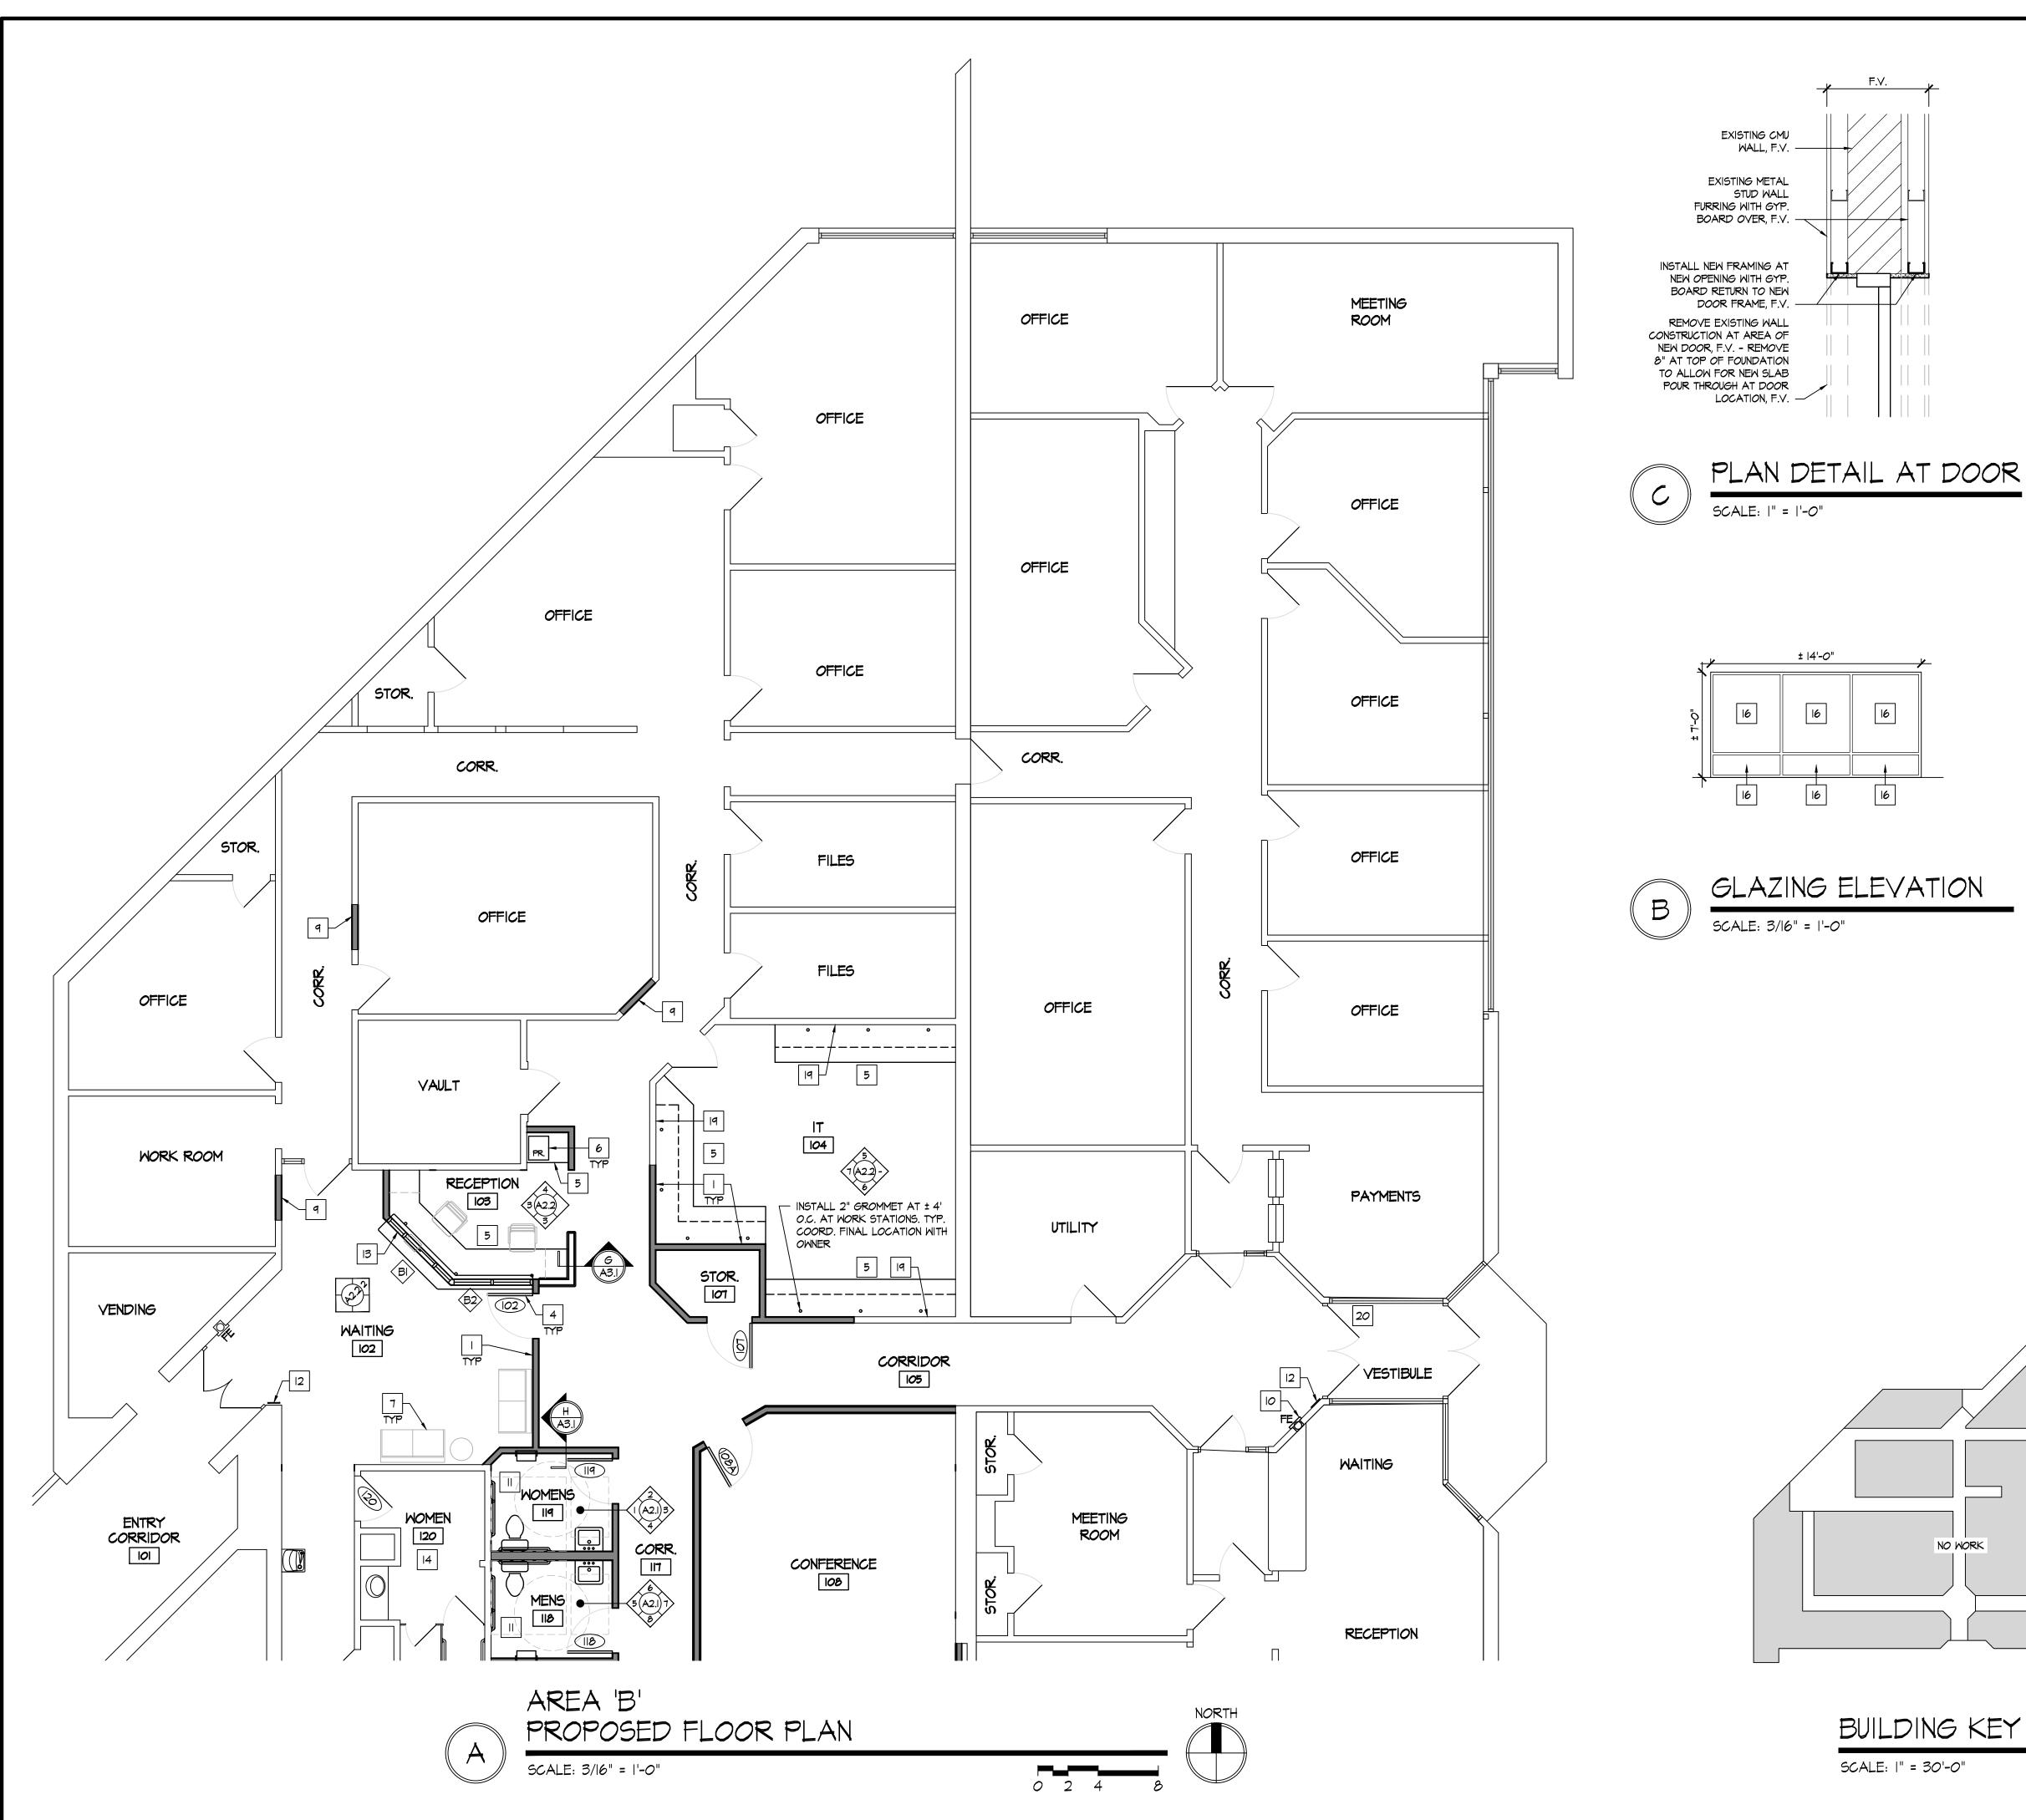

### \* NEW CONSTRUCTION KEY NOTES

- NEW METAL STUD FRAME WALL W/ GYPSUM BOARD FINISHES. REFER TO WALL TYPES ON SHEET AI.3.
- 2. NOT USED
- 3. NOT USED 4. NEW / SALVAGED DOOR, FRAME, AND HARDWARE, TYP. REFER TO DOOR
- 5. NEW CASEWORK, REFER TO INTERIOR ELEVATIONS / DETAILS. PROVIDE FRT
- 6. EQUIPMENT BY OWNER, TYP. (PROVIDE BLOCKING FOR WALL MOUNTED ITEMS,
- 7. FURNISHINGS BY OWNER, TYP.
- 8. NOT USED
- 9. INFILL OPENING IN METAL STUD WALL. MATCH IN LIKE KIND / FINISH FLUSH TO PROVIDE A UNIFORM FINISH.
- IO. INSTALL NEW SEMI RECESSED FIRE EXTINGUISHER CABINET. COORDINATE FINAL LOCATION WITH FIRE DEPARTMENT AS APPLICABLE.
- II. NEW PLUMBING FIXTURES AND ACCESSORIES. REFER TO INTERIOR ELEVATIONS. EXTEND SUPPLY/SANITARY PIPING FROM EXISTING. REFER TO P/M/E DRAWINGS
- 12. INSTALL TACTILE EXIT SIGN ADJACENT TO ALL EGRESS DOORS, TYP.
- 13. NEW BALLISTIC INTERIOR TRANSACTION WINDOW, INSTALL NEW TRANSACTION COUNTERTOP. REFER TO WINDOW SCHEDULE AND INTERIOR ELEVATIONS.
- 14. EXISTING TOILET ROOM PLUMBING FIXTURES & ACCESSORIES TO REMAIN. 15. INFILL OPENING W/ 3 5/8" METAL STUDS AT 16" O.C., 3" SOUND BATT
- INSULATION, AND [2] LAYERS OF 5/8" NOISE REDUCING GYPSUM BOARD. 16. INSTALL 3M BLACKOUT FILM ON INTERIOR FACE OF EXISTING GLAZING SYSTEM. REFER TO B/AI.2.
- 17. INSTALL NEW LINTEL AT NEW DOOR OPENING. REFER TO DETAIL A/A3.I. -
- PROVIDE GYP. BOARD RETURNS AT NEW H.M. DOOR FRAME. 18. PROVIDE 3/4" THICK 4'x4' FRT PLYWOOD BACK BOARD FOR IT EQUIPMENT.
- COORD. MOUNTING LOCATION WITH OWNER. 19. CUT / PATCH EXIST GYP. BOARD TO ALLOW FOR INSTALL OF FRT
- BLOCKING FOR WALL MOUNTED SHELVING AT EXISTING WALLS, TYP. 20. CARD READER ACCESS TO BE PROVIDED AT EXISTING DOOR. COORD.

WITH OWNER'S SECURITY CONSULTANT [ISM].

± |4'-0" 16


EXISTING CMU


WALL, F.V.

STUD WALL

LOCATION, F.V.

SCALE: |" = |'-0"

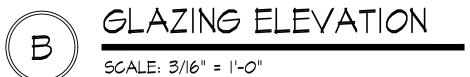

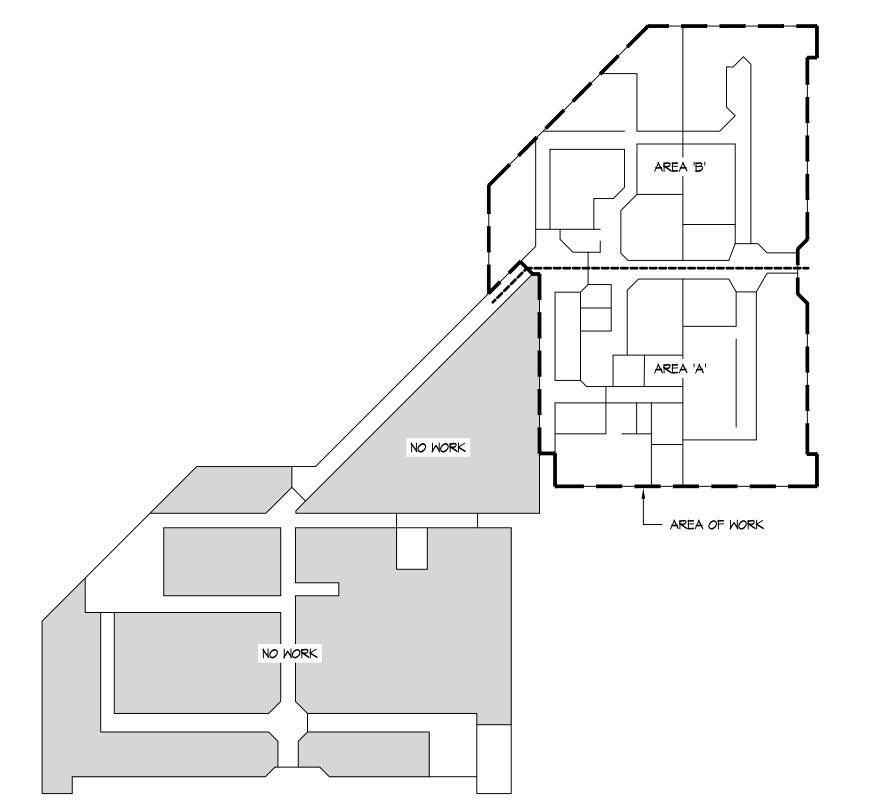

BUILDING KEY PLAN SCALE: |" = 30'-0"

RDA ARCHITECTS Dayton, Ohio 45459

JONATHAN ROBERT SCHAAF Jonathan Robert Schaaf #14503 Expiration Date 12/31/2023

7945 Washingtor

O: 937.610.3440

Woods Drive

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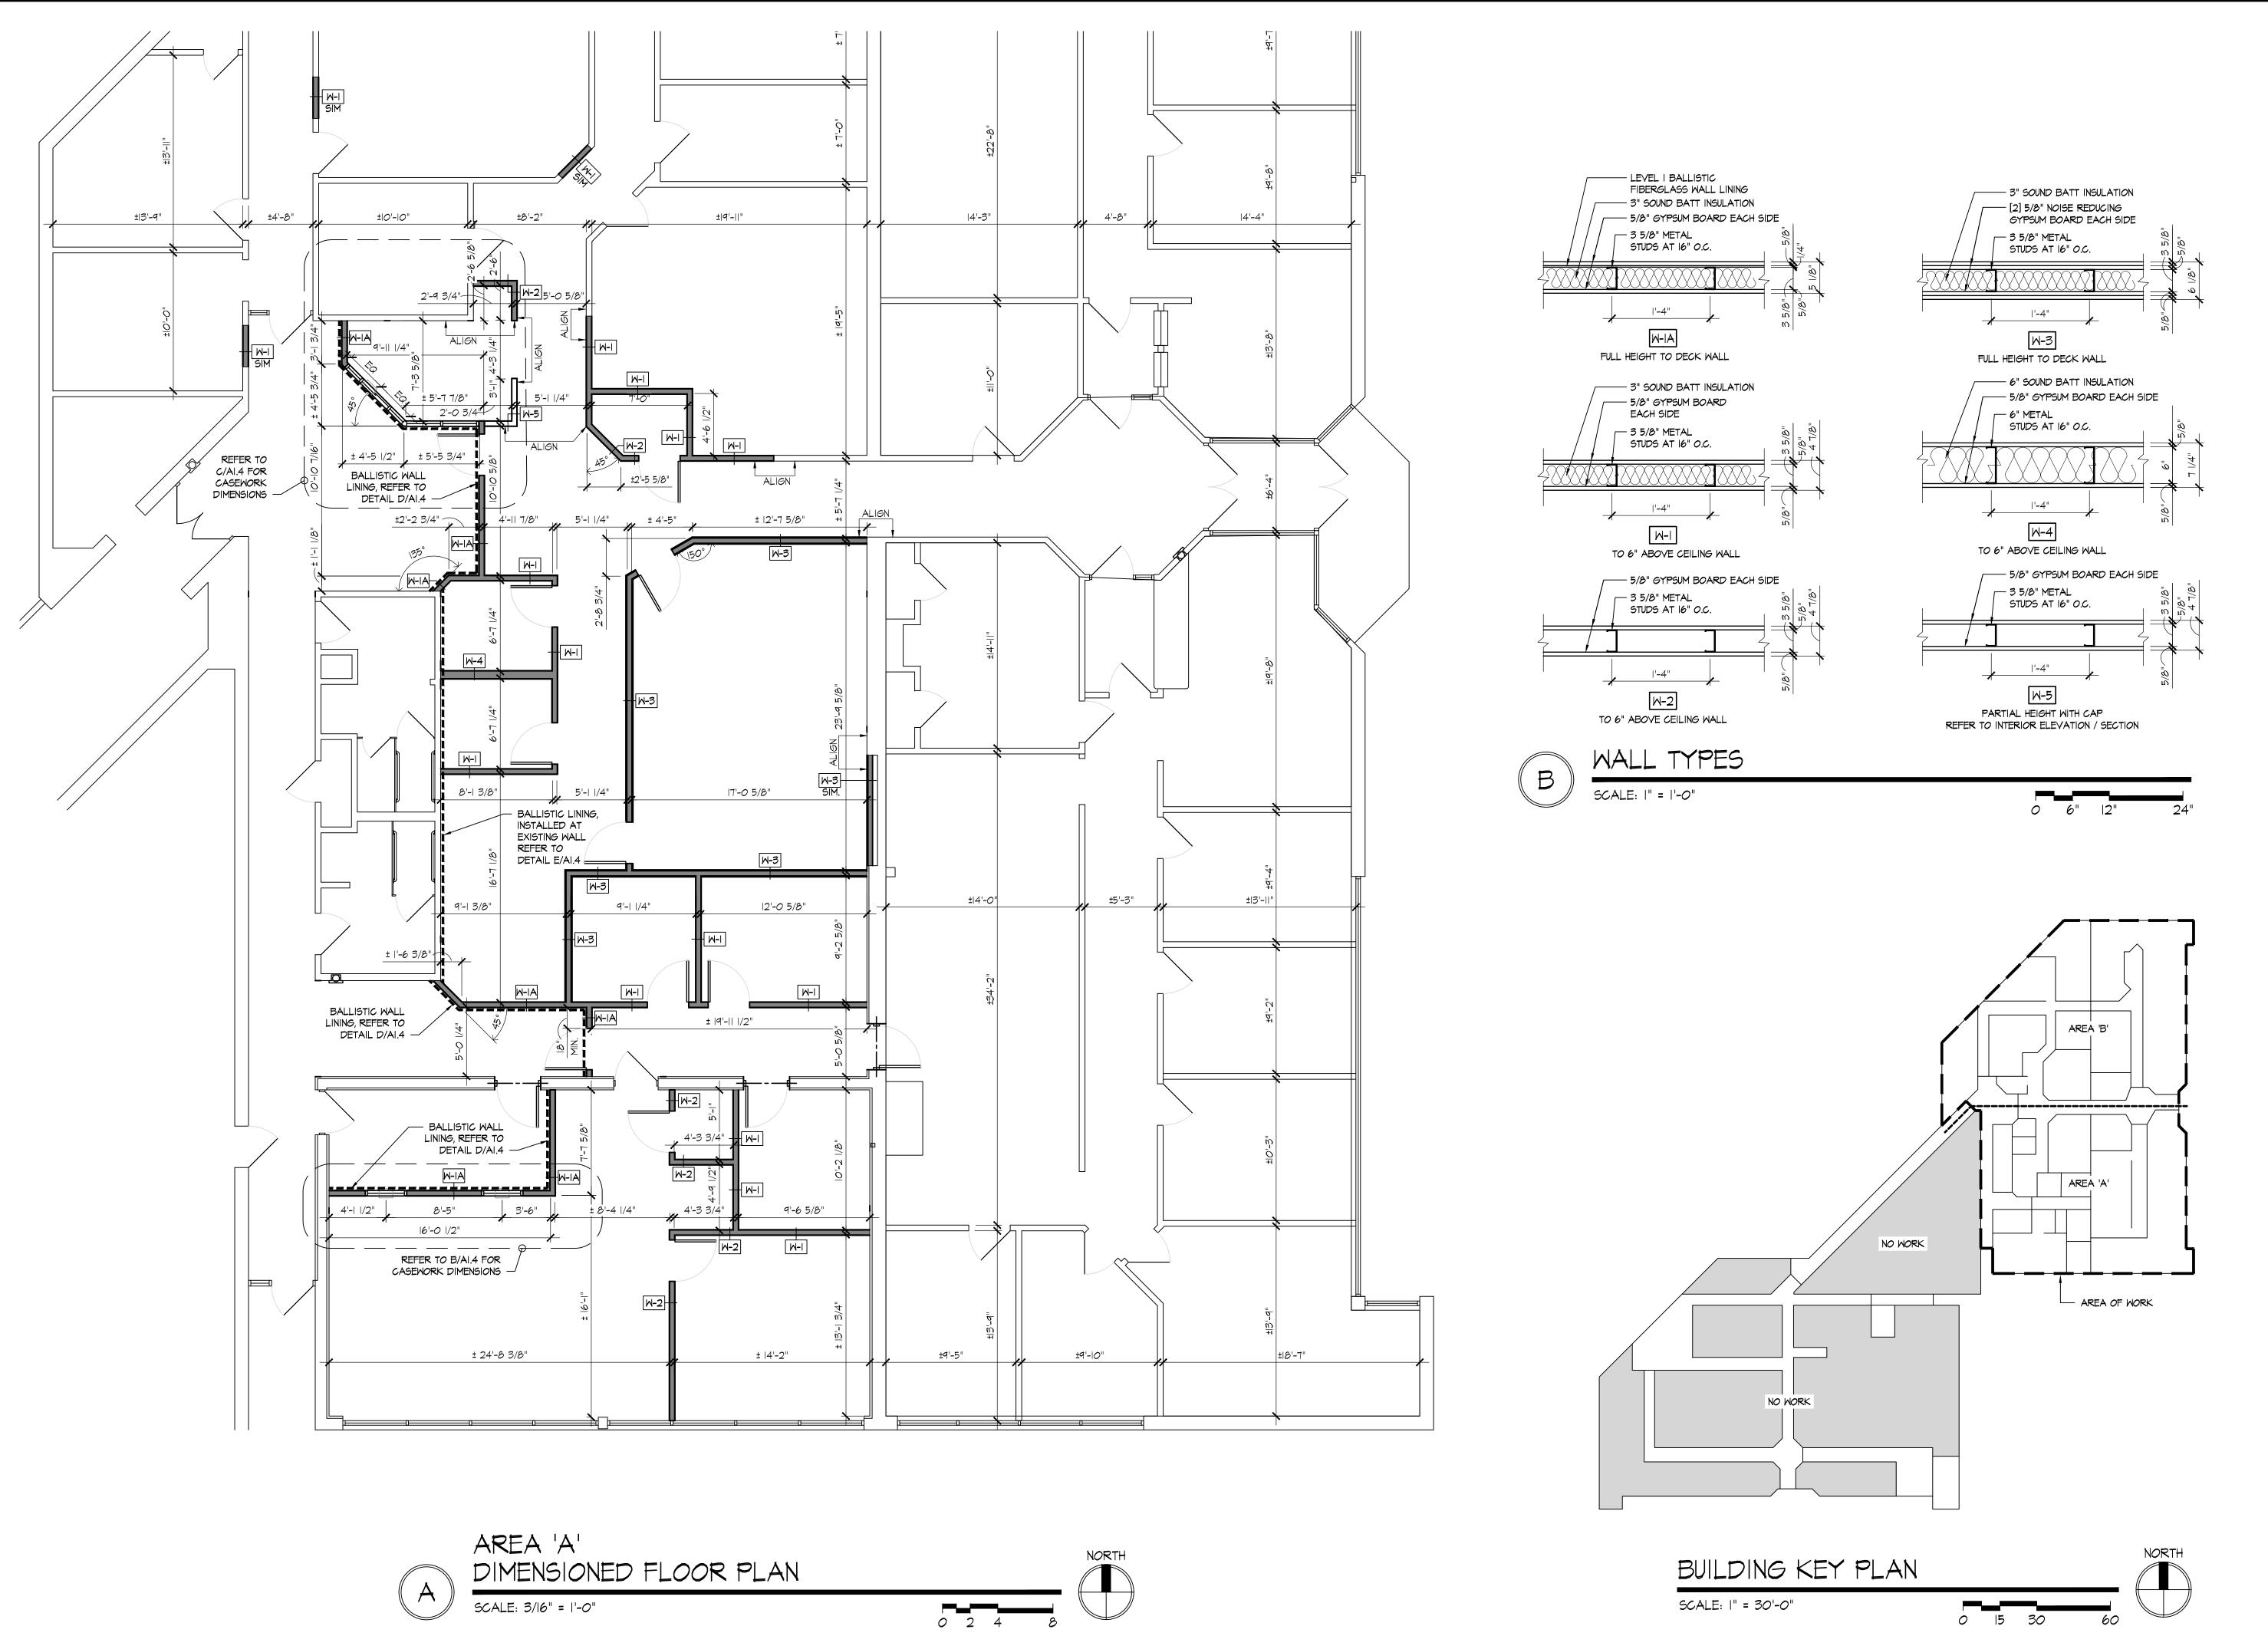
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Date

March 29, 2023 Sheet Title

AREA 'B' PROPOSED FLOOR PLAN





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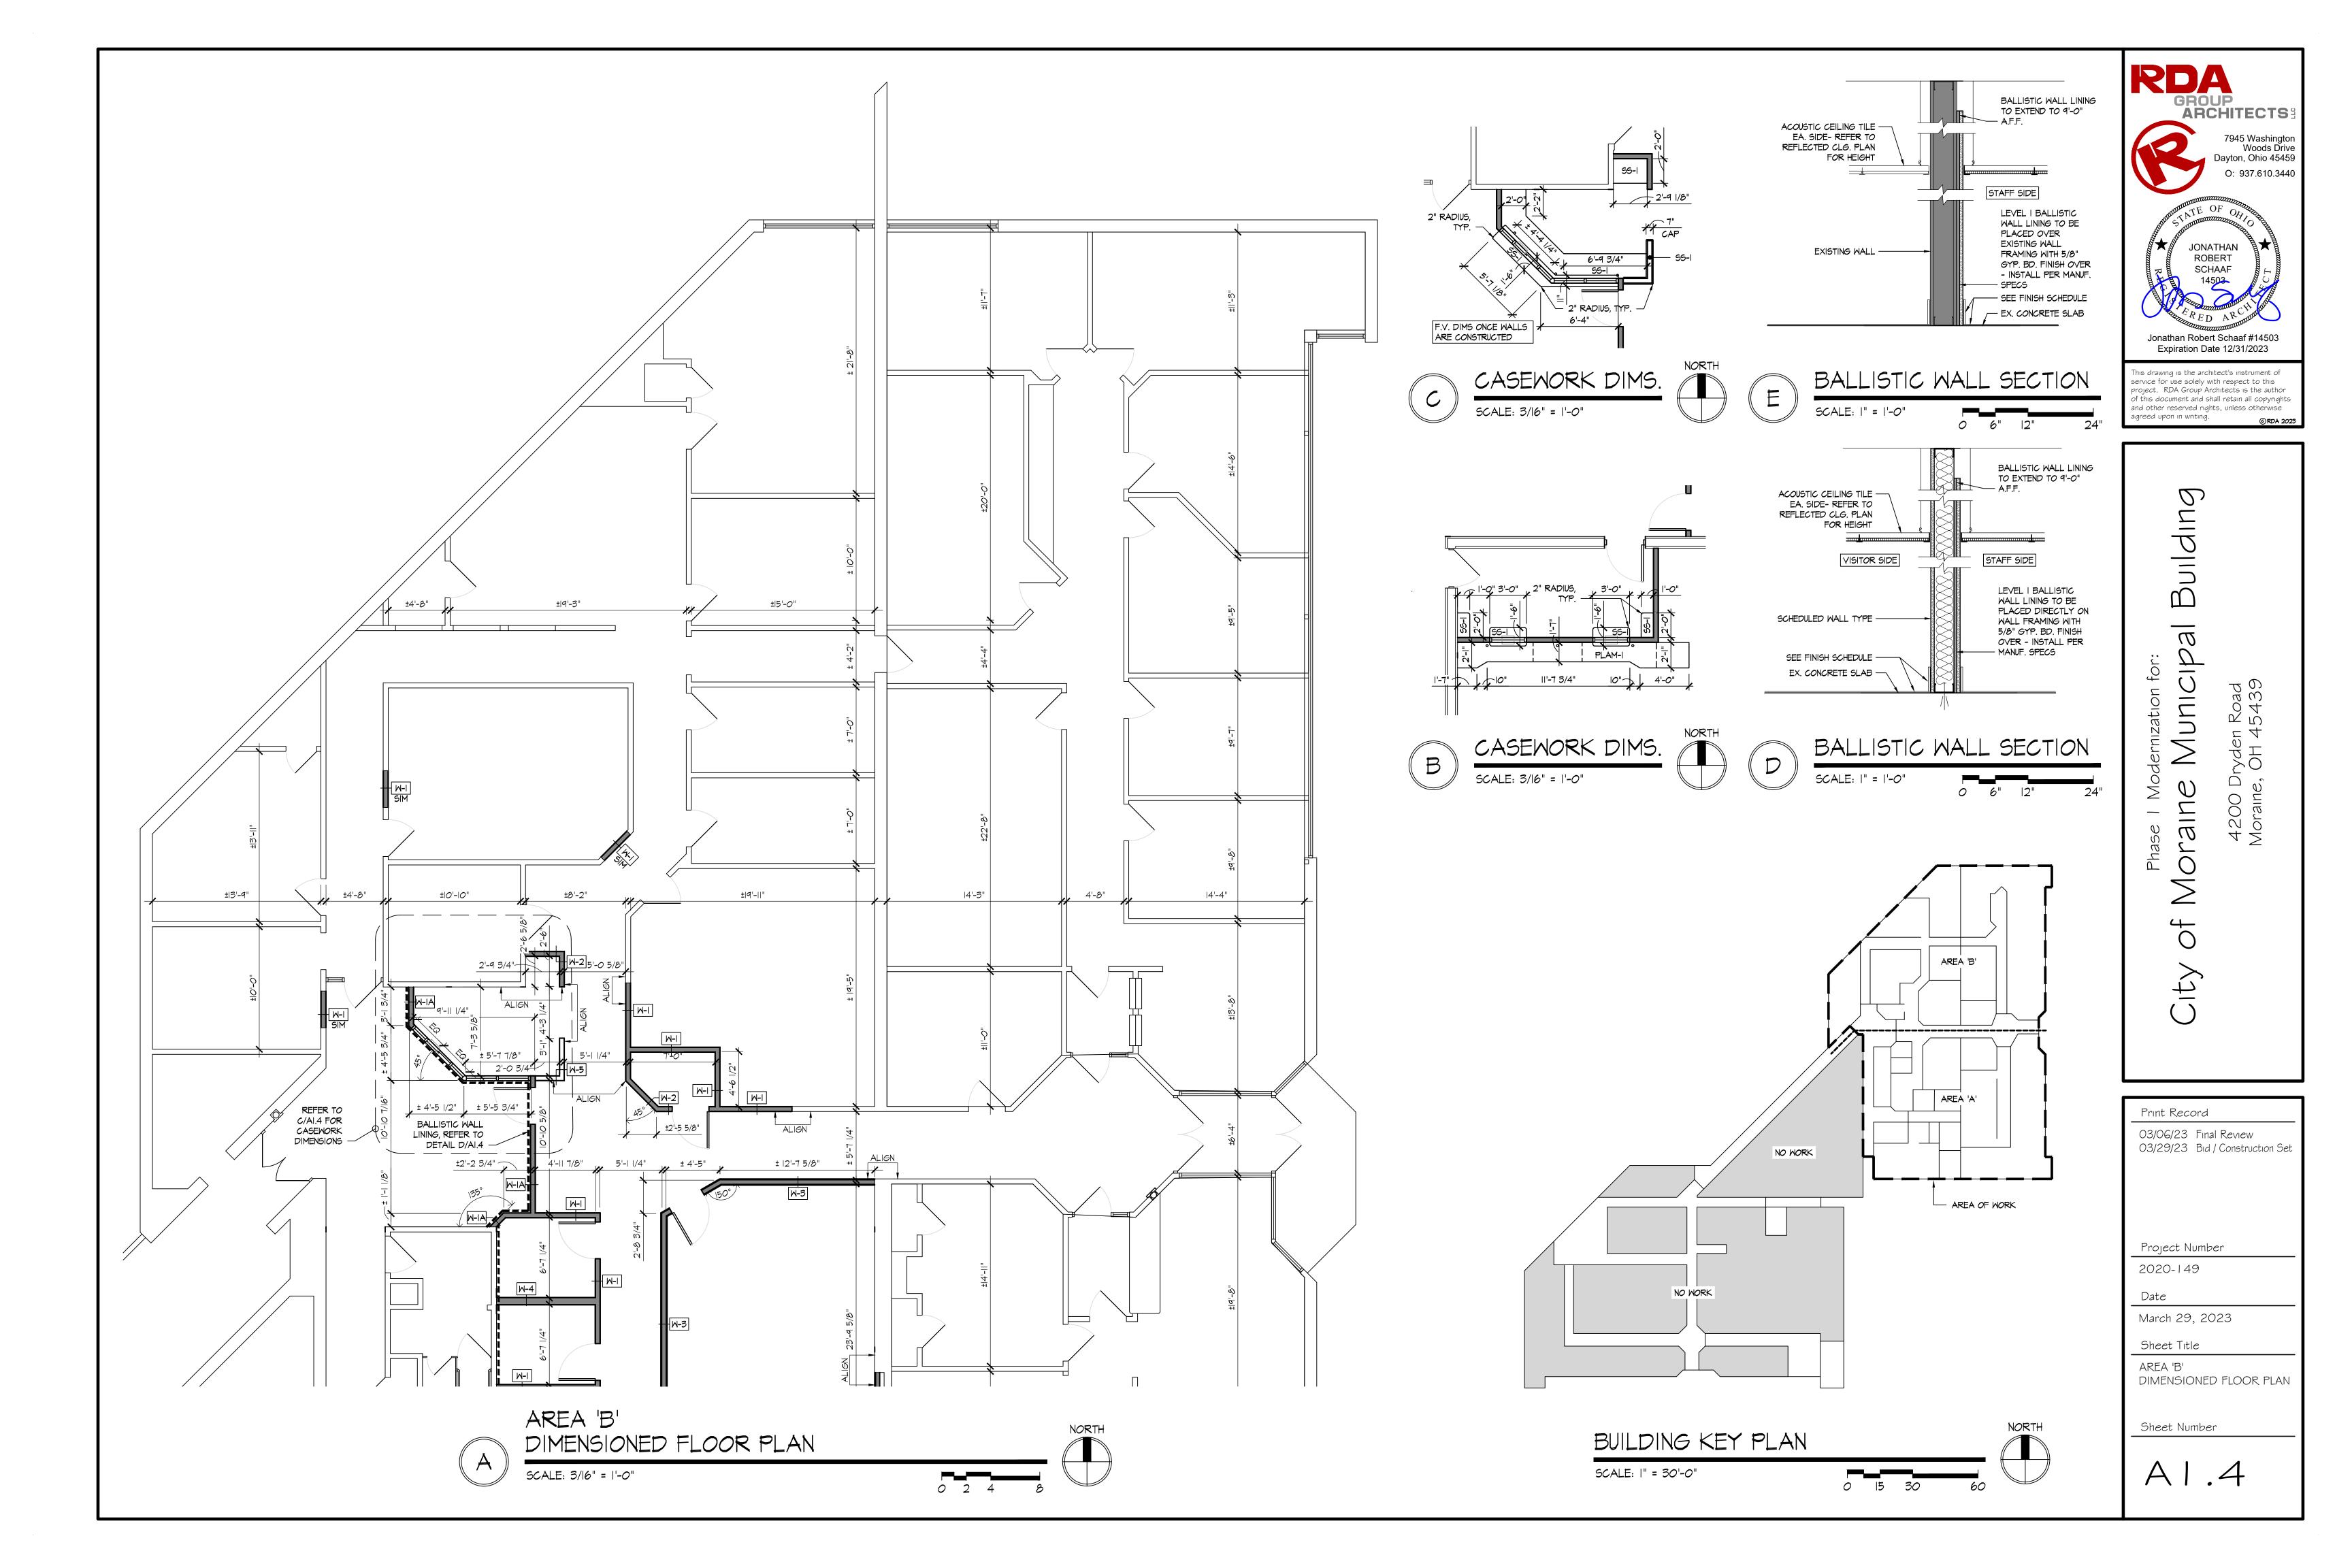
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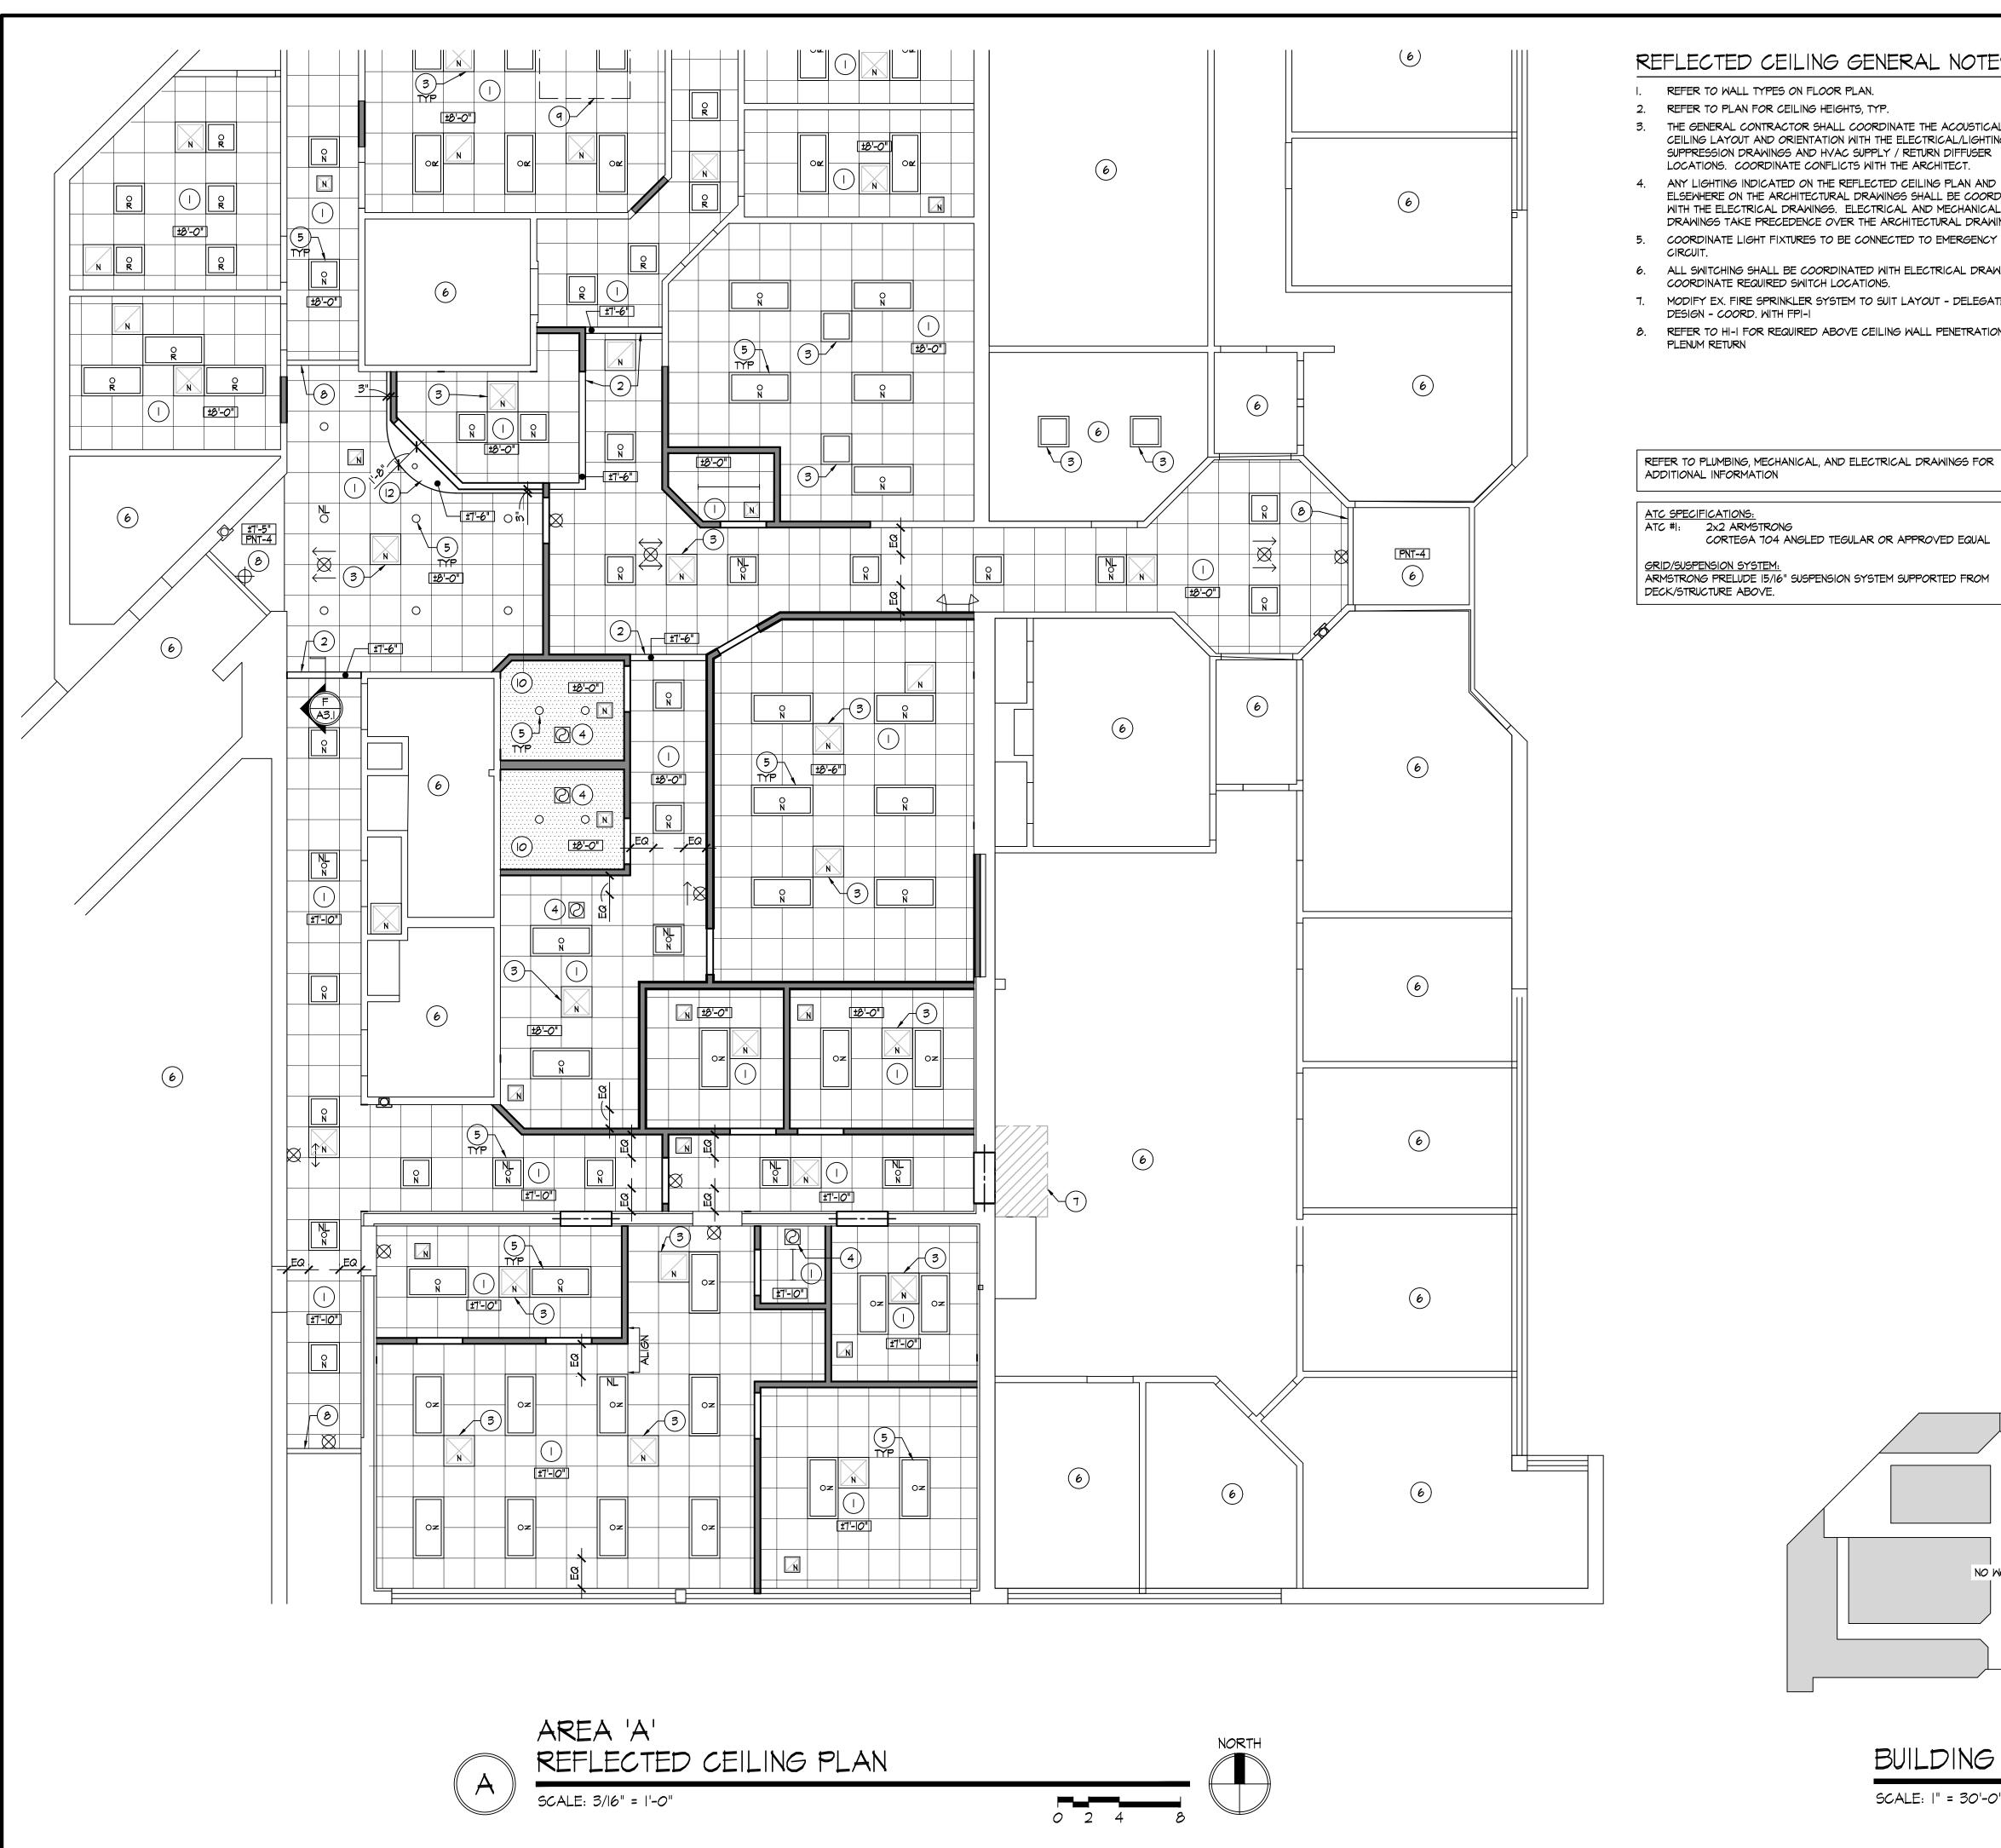
Date

March 29, 2023

Sheet Title

AREA 'A' DIMENSIONED FLOOR PLAN






### REFLECTED CEILING GENERAL NOTES

- REFER TO WALL TYPES ON FLOOR PLAN.
- 2. REFER TO PLAN FOR CEILING HEIGHTS, TYP.
- 3. THE GENERAL CONTRACTOR SHALL COORDINATE THE ACOUSTICAL TILE CEILING LAYOUT AND ORIENTATION WITH THE ELECTRICAL/LIGHTING/FIRE SUPPRESSION DRAWINGS AND HVAC SUPPLY / RETURN DIFFUSER LOCATIONS. COORDINATE CONFLICTS WITH THE ARCHITECT.
- 4. ANY LIGHTING INDICATED ON THE REFLECTED CEILING PLAN AND ELSEWHERE ON THE ARCHITECTURAL DRAWINGS SHALL BE COORDINATED WITH THE ELECTRICAL DRAWINGS. ELECTRICAL AND MECHANICAL DRAWINGS TAKE PRECEDENCE OVER THE ARCHITECTURAL DRAWINGS.
- 5. COORDINATE LIGHT FIXTURES TO BE CONNECTED TO EMERGENCY LIGHTING
- 6. ALL SWITCHING SHALL BE COORDINATED WITH ELECTRICAL DRAWINGS. COORDINATE REQUIRED SWITCH LOCATIONS.
- 7. MODIFY EX. FIRE SPRINKLER SYSTEM TO SUIT LAYOUT DELEGATED
- 8. REFER TO HI-I FOR REQUIRED ABOVE CEILING WALL PENETRATIONS FOR

### (#) REFLECTED CEILING PLAN KEY NOTES

- ACOUSTICAL TILE CEILING [ATC-I] AT HEIGHT INDICATED.
- 2. GYPSUM BOARD BULKHEAD AT HEIGHT INDICATED.
- 3. HVAC GRILL / DIFFUSER / CASSETTE, REFER TO MECHANICAL DRAWINGS.
- 4. EXHAUST FAN. REFER TO MECHANICAL DRAWINGS.
- 5. LIGHT FIXTURE, REFER TO ELECTRICAL DRAWINGS.
- 6. EXISTING TO REMAIN NO WORK UNLESS NOTED OTHERWISE
- 7. REMOVE / REPLACE EXISTING CEILING AS NEEDED IN THIS AREA FOR INSTALLATION OF NEW DOOR. MATCH EXISTING IN LIKE KIND.
- 8. EXISTING GYP. BOARD SOFFIT TO REMAIN PAINT. 9. APPROXIMATE LOCATION OF NEW RTU. COORDINATE WITH MECHANICAL
- DRAWINGS.
- 10. GYPSUM BOARD CEILING AT HEIGHT INDICATED.
- II. EXISTING SKYLIGHT TO REMAIN.
- 12. GYPSUM BOARD BULKHEAD AT HEIGHT INDICATED. REFER TO SECTION

### SYMBOL LEGEND

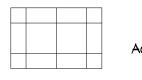


ACOUSTIC TILE CEILING, HEIGHT AS INDICATED



GYPSUM BOARD CEILING, HEIGHT AS INDICATED




2X4/2X2 LIGHT FIXTURE - COORD. W/ ELEC. DRAWINGS

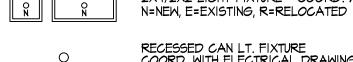

RECESSED CAN LT. FIXTURE COORD. WITH ELECTRICAL DRAWINGS




EXIT SIGN COORD. WITH ELECTRICAL DRAWINGS

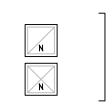


HVAC DIFFUSERS, REFER TO MECHANICAL DWG.


EXHAUST FAN - VENT DIRECT TO EXTERIOR -COORDINATE WITH HVAC DRAWINGS BY OTHERS

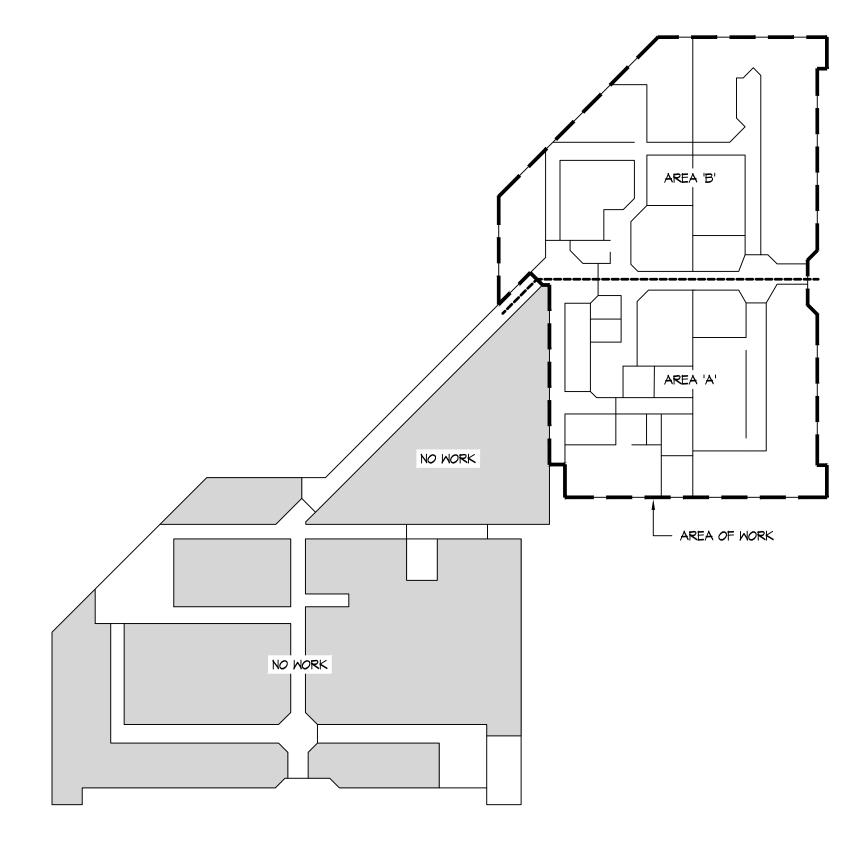



SCALE: |" = 30'-0"

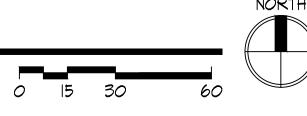

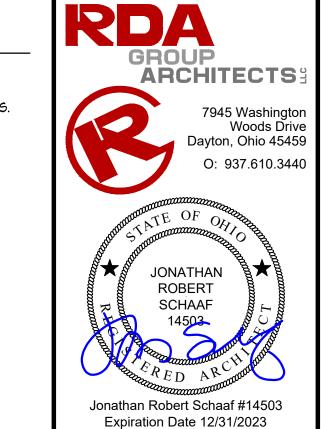

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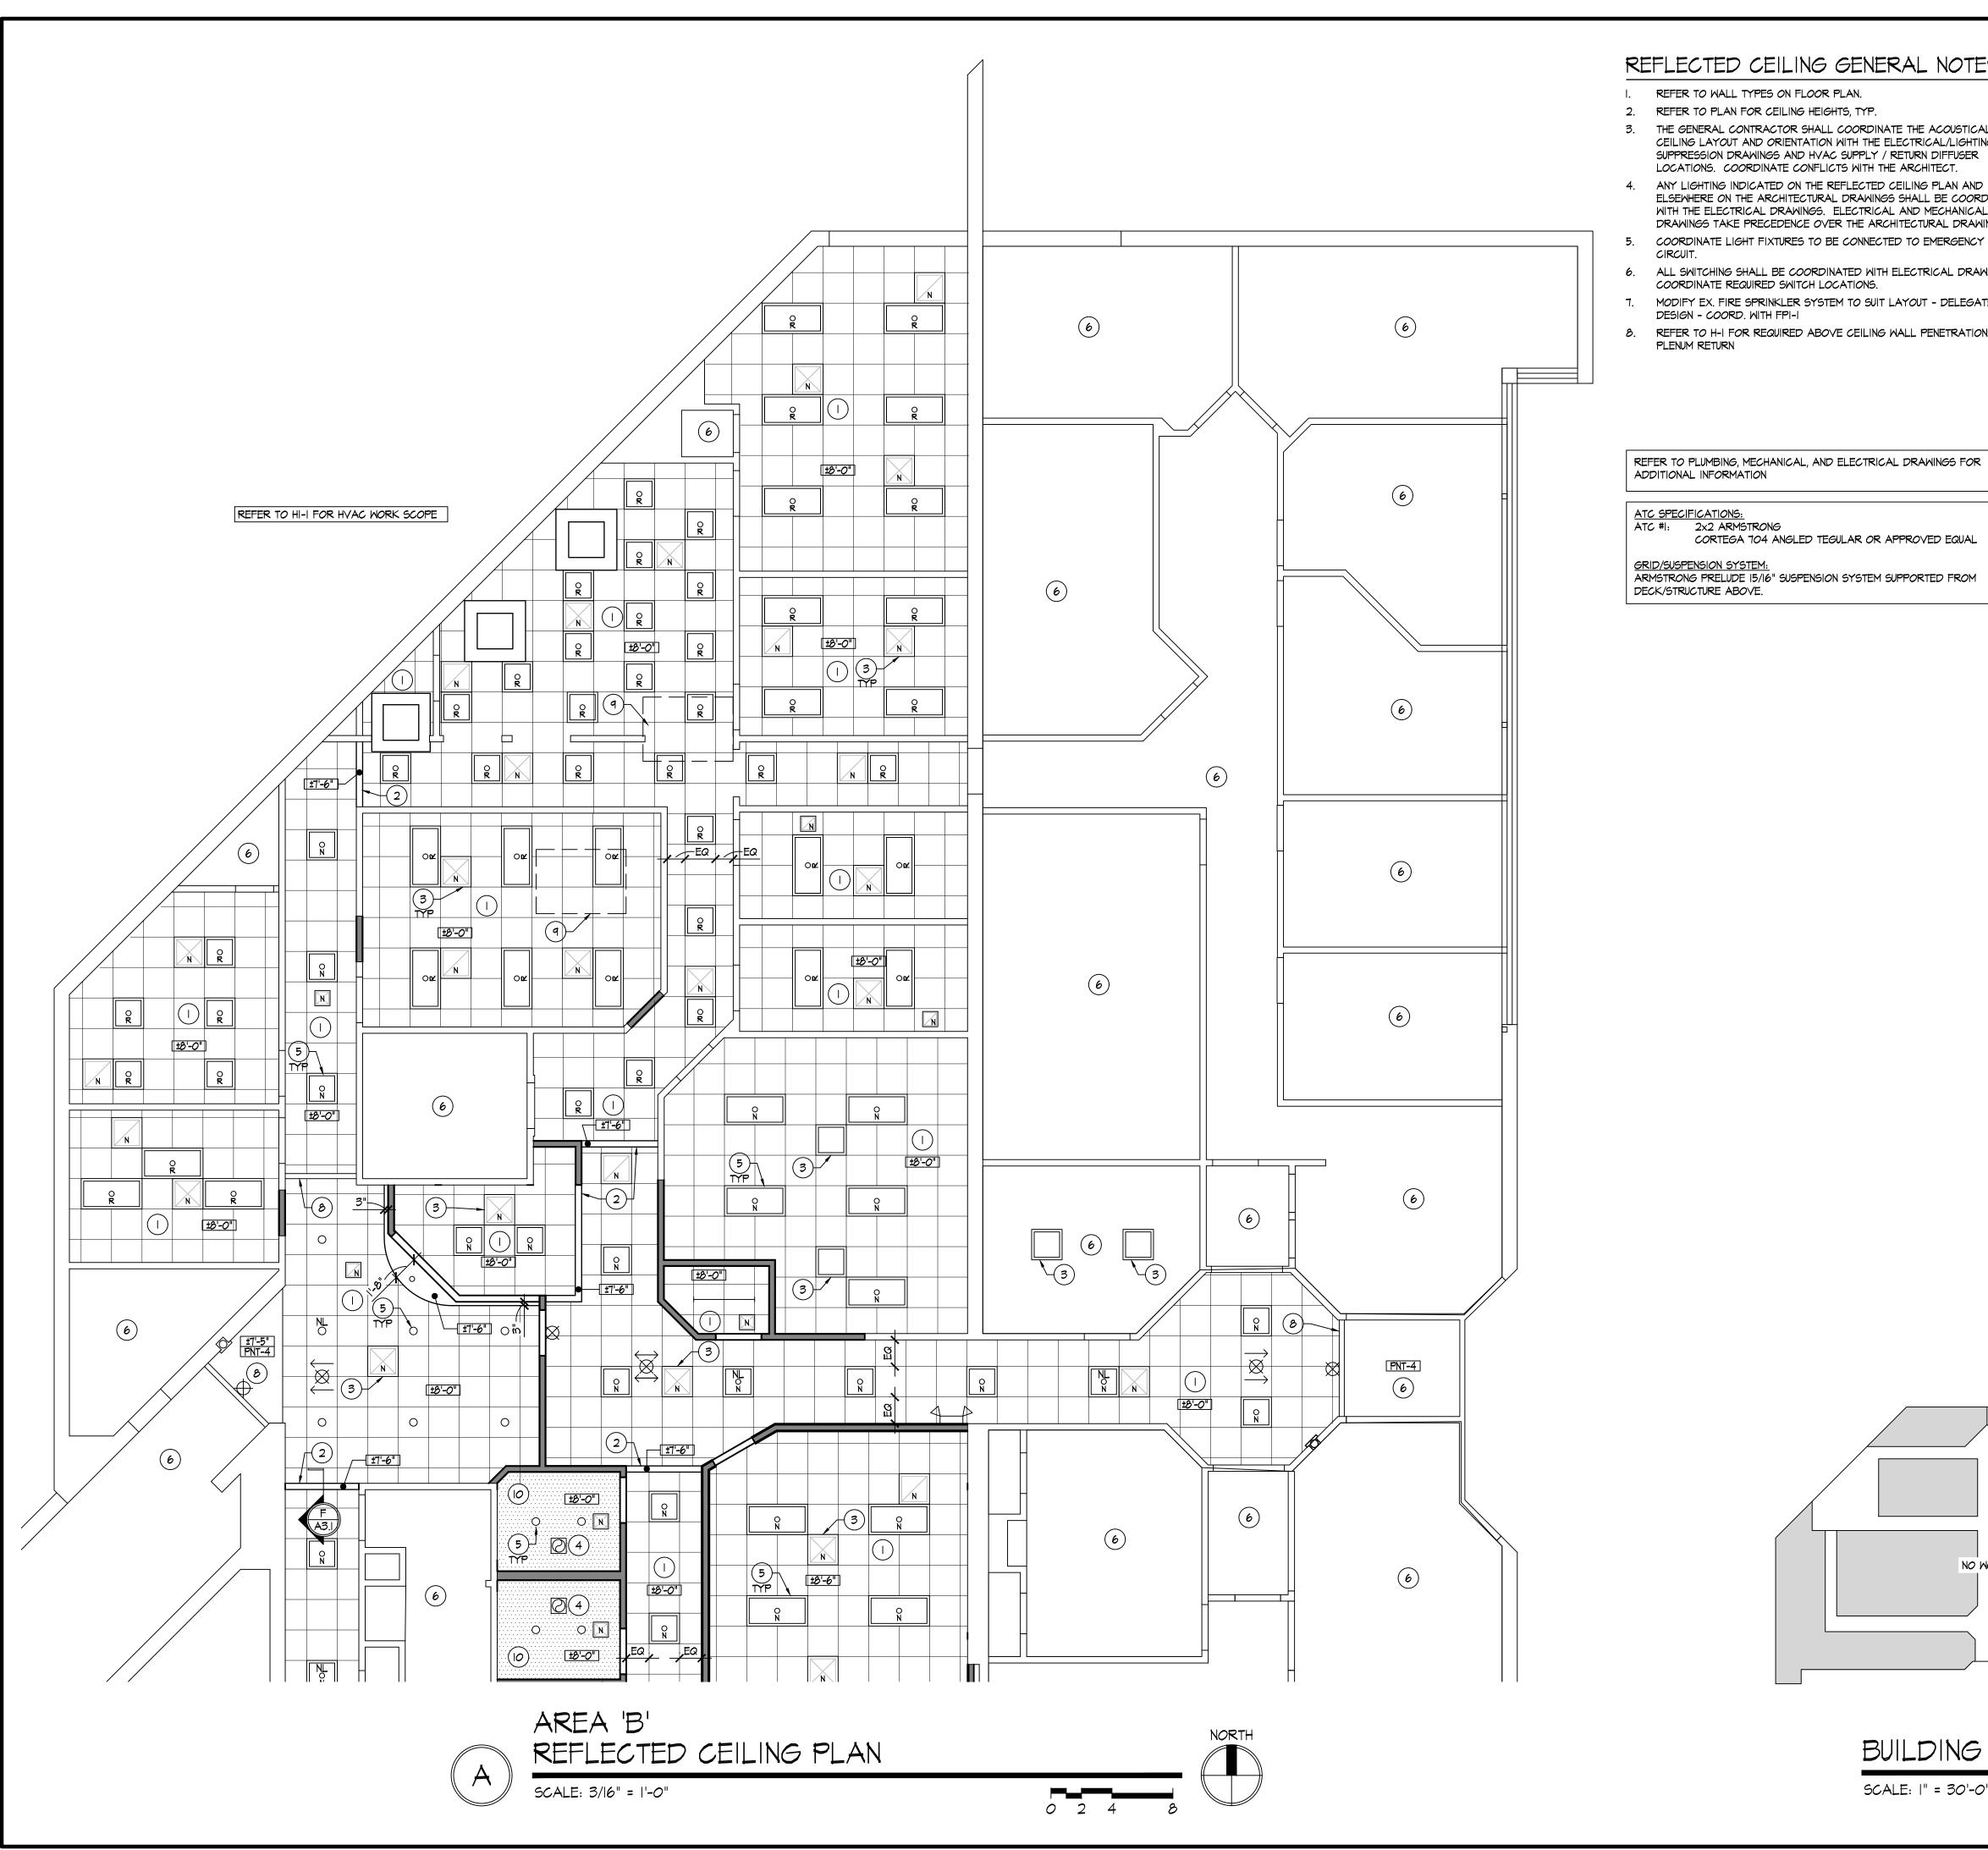
Project Number

2020-149 Date

March 29, 2023

Sheet Title

AREA 'A' REFLECTED CEILING PLAN



### REFLECTED CEILING GENERAL NOTES

- REFER TO WALL TYPES ON FLOOR PLAN.
- 2. REFER TO PLAN FOR CEILING HEIGHTS, TYP.
- 3. THE GENERAL CONTRACTOR SHALL COORDINATE THE ACOUSTICAL TILE CEILING LAYOUT AND ORIENTATION WITH THE ELECTRICAL/LIGHTING/FIRE SUPPRESSION DRAWINGS AND HVAC SUPPLY / RETURN DIFFUSER LOCATIONS. COORDINATE CONFLICTS WITH THE ARCHITECT.
- 4. ANY LIGHTING INDICATED ON THE REFLECTED CEILING PLAN AND ELSEWHERE ON THE ARCHITECTURAL DRAWINGS SHALL BE COORDINATED WITH THE ELECTRICAL DRAWINGS. ELECTRICAL AND MECHANICAL DRAWINGS TAKE PRECEDENCE OVER THE ARCHITECTURAL DRAWINGS.
- COORDINATE LIGHT FIXTURES TO BE CONNECTED TO EMERGENCY LIGHTING
- 6. ALL SWITCHING SHALL BE COORDINATED WITH ELECTRICAL DRAWINGS. COORDINATE REQUIRED SWITCH LOCATIONS.
- 7. MODIFY EX. FIRE SPRINKLER SYSTEM TO SUIT LAYOUT DELEGATED
- 8. REFER TO H-I FOR REQUIRED ABOVE CEILING WALL PENETRATIONS FOR PLENUM RETURN

### DESIGN - COORD. WITH FPI-I

CORTEGA 704 ANGLED TEGULAR OR APPROVED EQUAL

### SYMBOL LEGEND

ACOUSTIC TILE CEILING, HEIGHT AS INDICATED

GYPSUM BOARD CEILING, HEIGHT AS INDICATED


2X4/2X2 LIGHT FIXTURE - COORD. W/ ELEC. DRAWINGS N=NEW, E=EXISTING, R=RELOCATED


2' / 4' SURFACE MOUNT STRIP LIGHT FIXTURE COORD. WITH ELECTRICAL DRAWINGS

EXIT SIGN COORD. WITH ELECTRICAL DRAWINGS

HVAC DIFFUSERS, REFER TO MECHANICAL DWG.

EXHAUST FAN - VENT DIRECT TO EXTERIOR -COORDINATE WITH HVAC DRAWINGS BY OTHERS

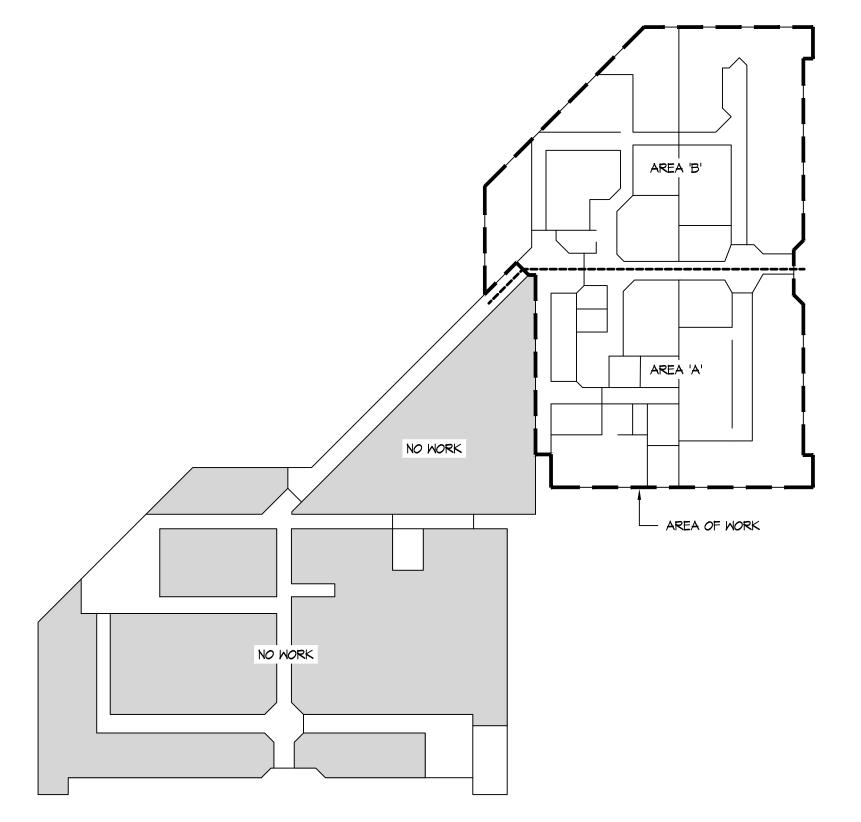

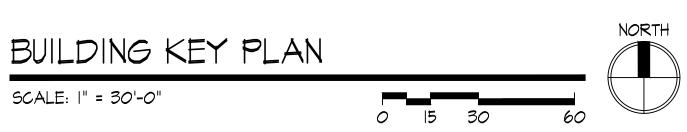





- ACOUSTICAL TILE CEILING [ATC-I] AT HEIGHT INDICATED.
- 2. GYPSUM BOARD BULKHEAD AT HEIGHT INDICATED.
- 3. HVAC GRILL / DIFFUSER / CASSETTE, REFER TO MECHANICAL DRAWINGS. 4. EXHAUST FAN. REFER TO MECHANICAL DRAWINGS.
- 5. LIGHT FIXTURE, REFER TO ELECTRICAL DRAWINGS.
- 6. EXISTING TO REMAIN NO WORK UNLESS NOTED OTHERWISE
- 7. REMOVE / REPLACE EXISTING CEILING AS NEEDED IN THIS AREA FOR INSTALLATION OF NEW DOOR. MATCH EXISTING IN LIKE KIND.
- 9. APPROXIMATE LOCATION OF NEW RTU. COORDINATE WITH MECHANICAL
- 10. GYPSUM BOARD CEILING AT HEIGHT INDICATED.

8. EXISTING GYP. BOARD SOFFIT TO REMAIN - PAINT.


II. EXISTING SKYLIGHT TO REMAIN.

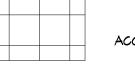

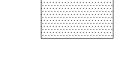




RECESSED CAN LT. FIXTURE COORD. WITH ELECTRICAL DRAWINGS

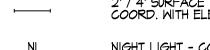

NIGHT LIGHT - COORD. W/ ELEC. DRAWINGS

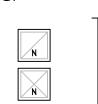

03/29/23 Bid / Construction Set Project Number 2020-149 Date March 29, 2023

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ROBERT

SCHAAF

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ARCHITECTS


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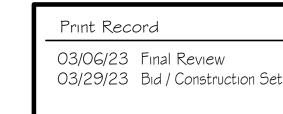
O: 937.610.3440

Dayton, Ohio 45459

Woods Drive

Sheet Title AREA 'B' REFLECTED CEILING PLAN



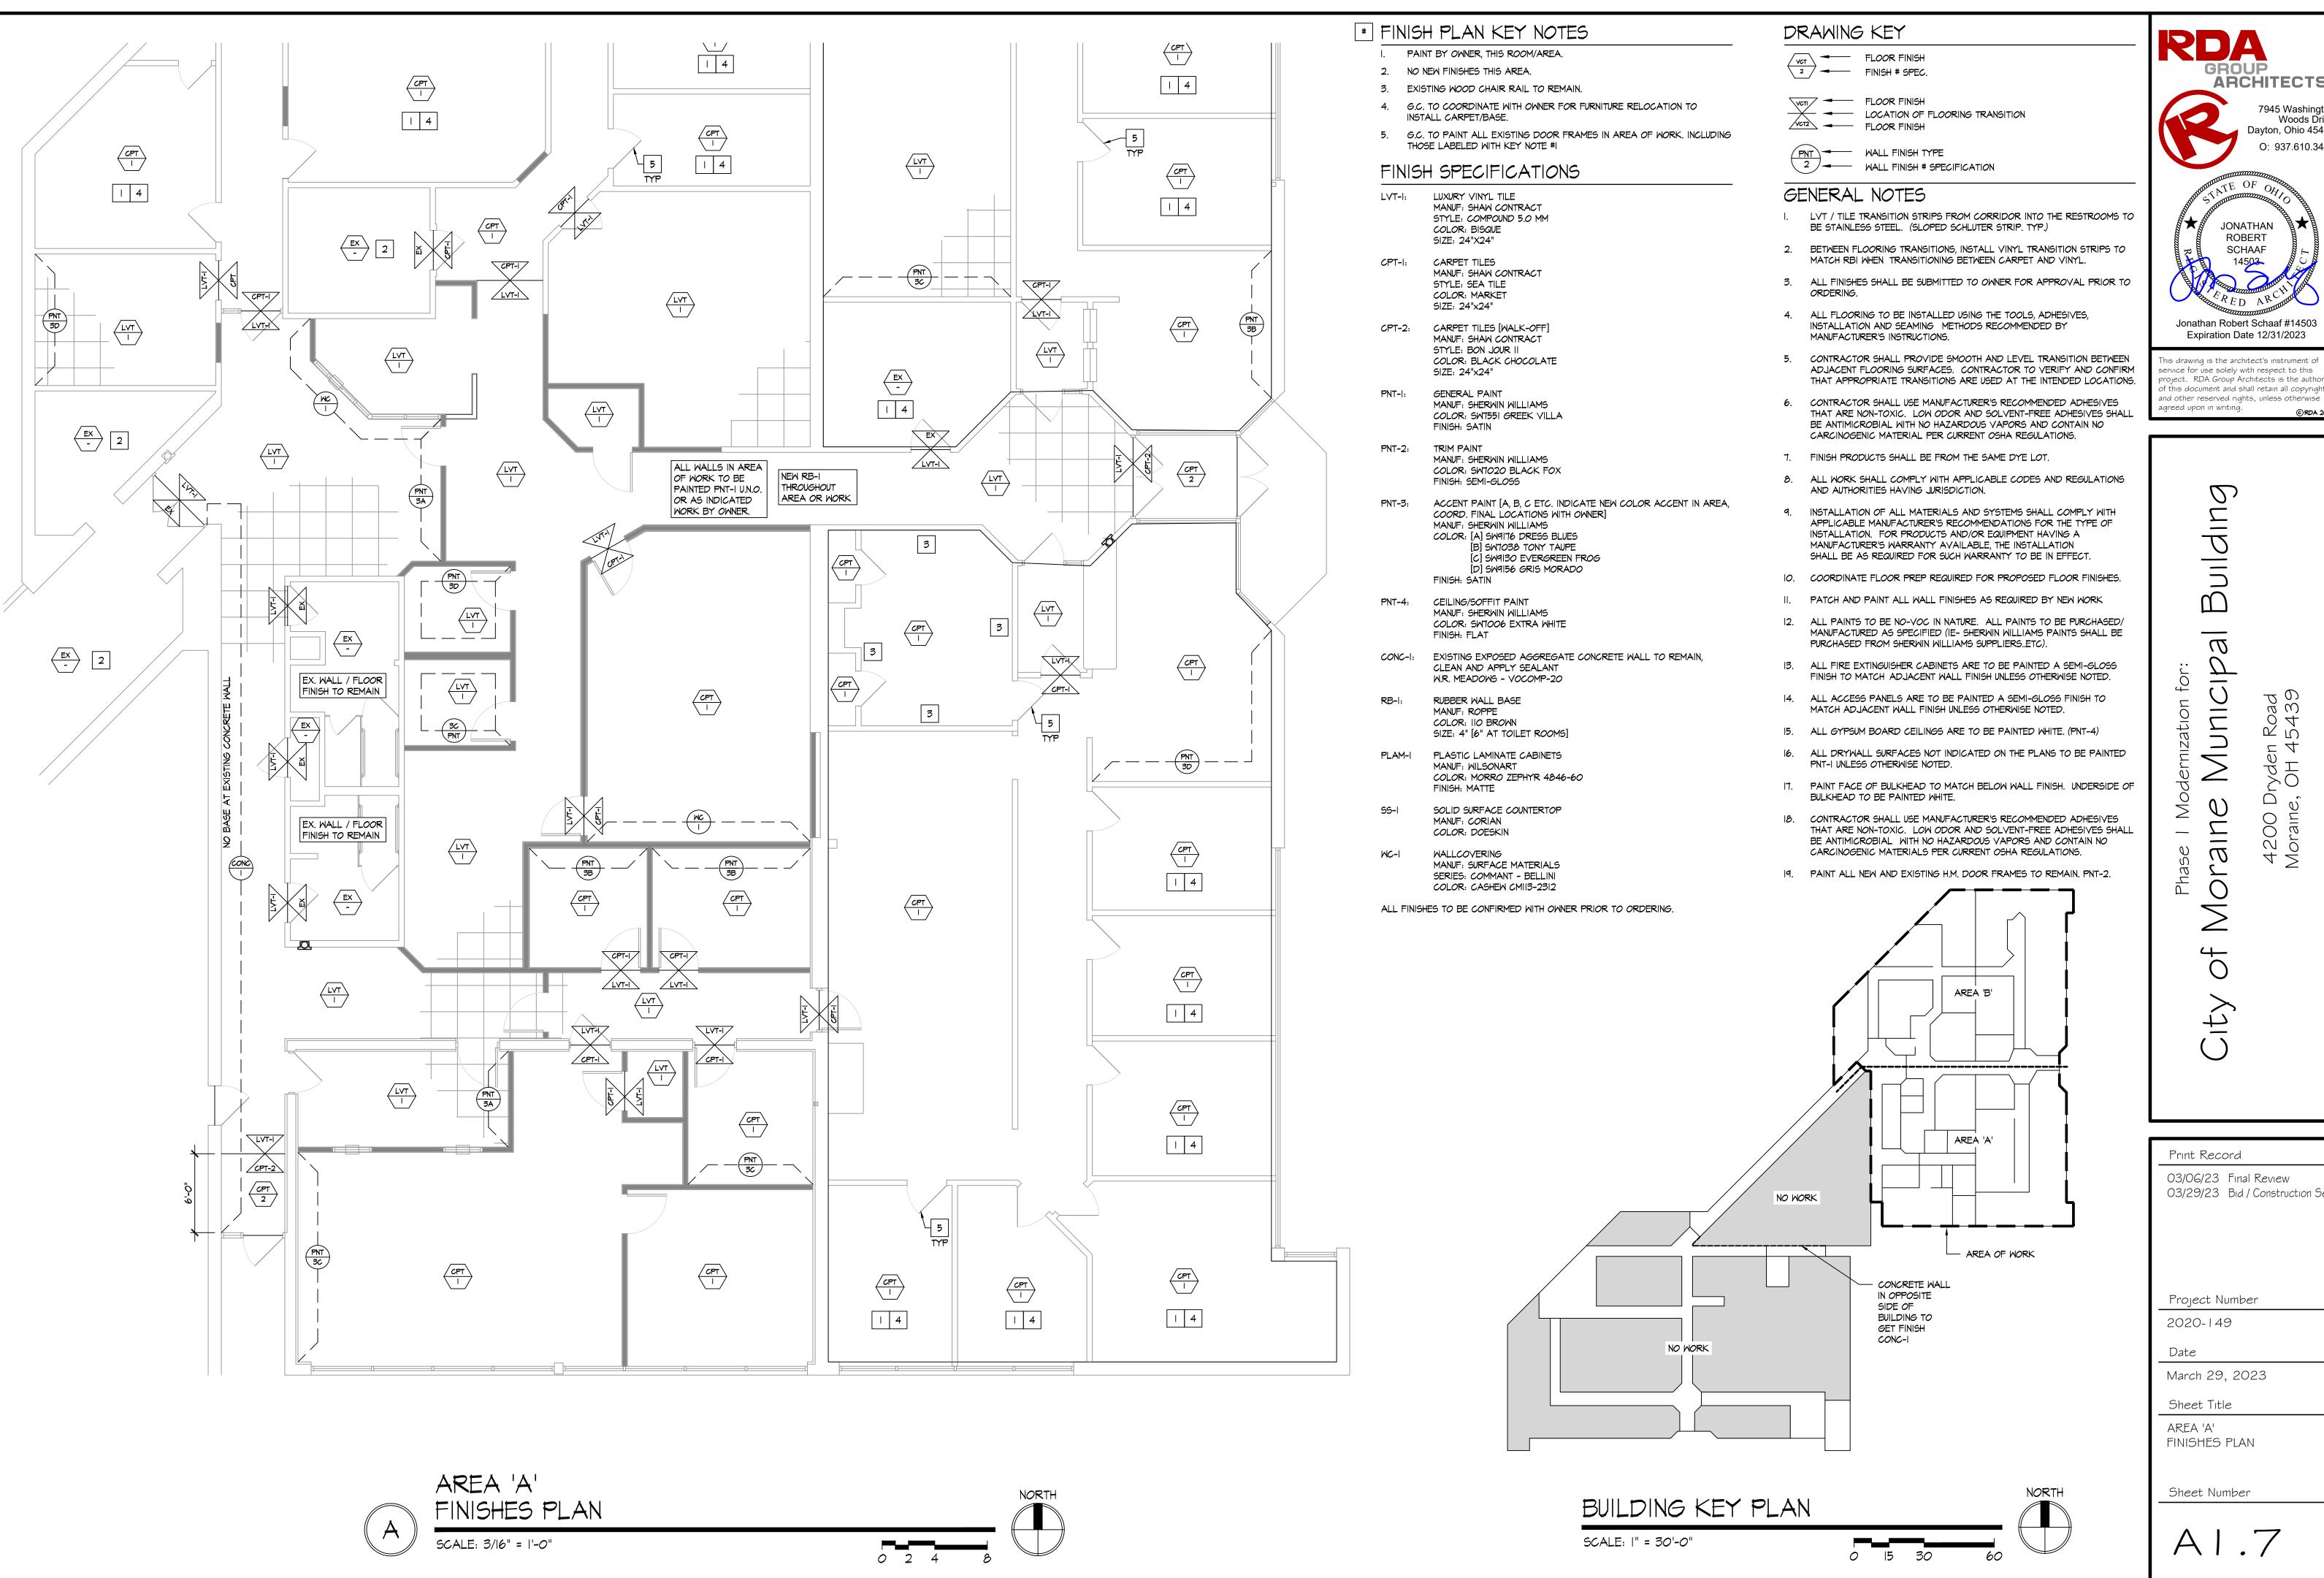

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Jonathan Robert Schaaf #14503

Expiration Date 12/31/2023

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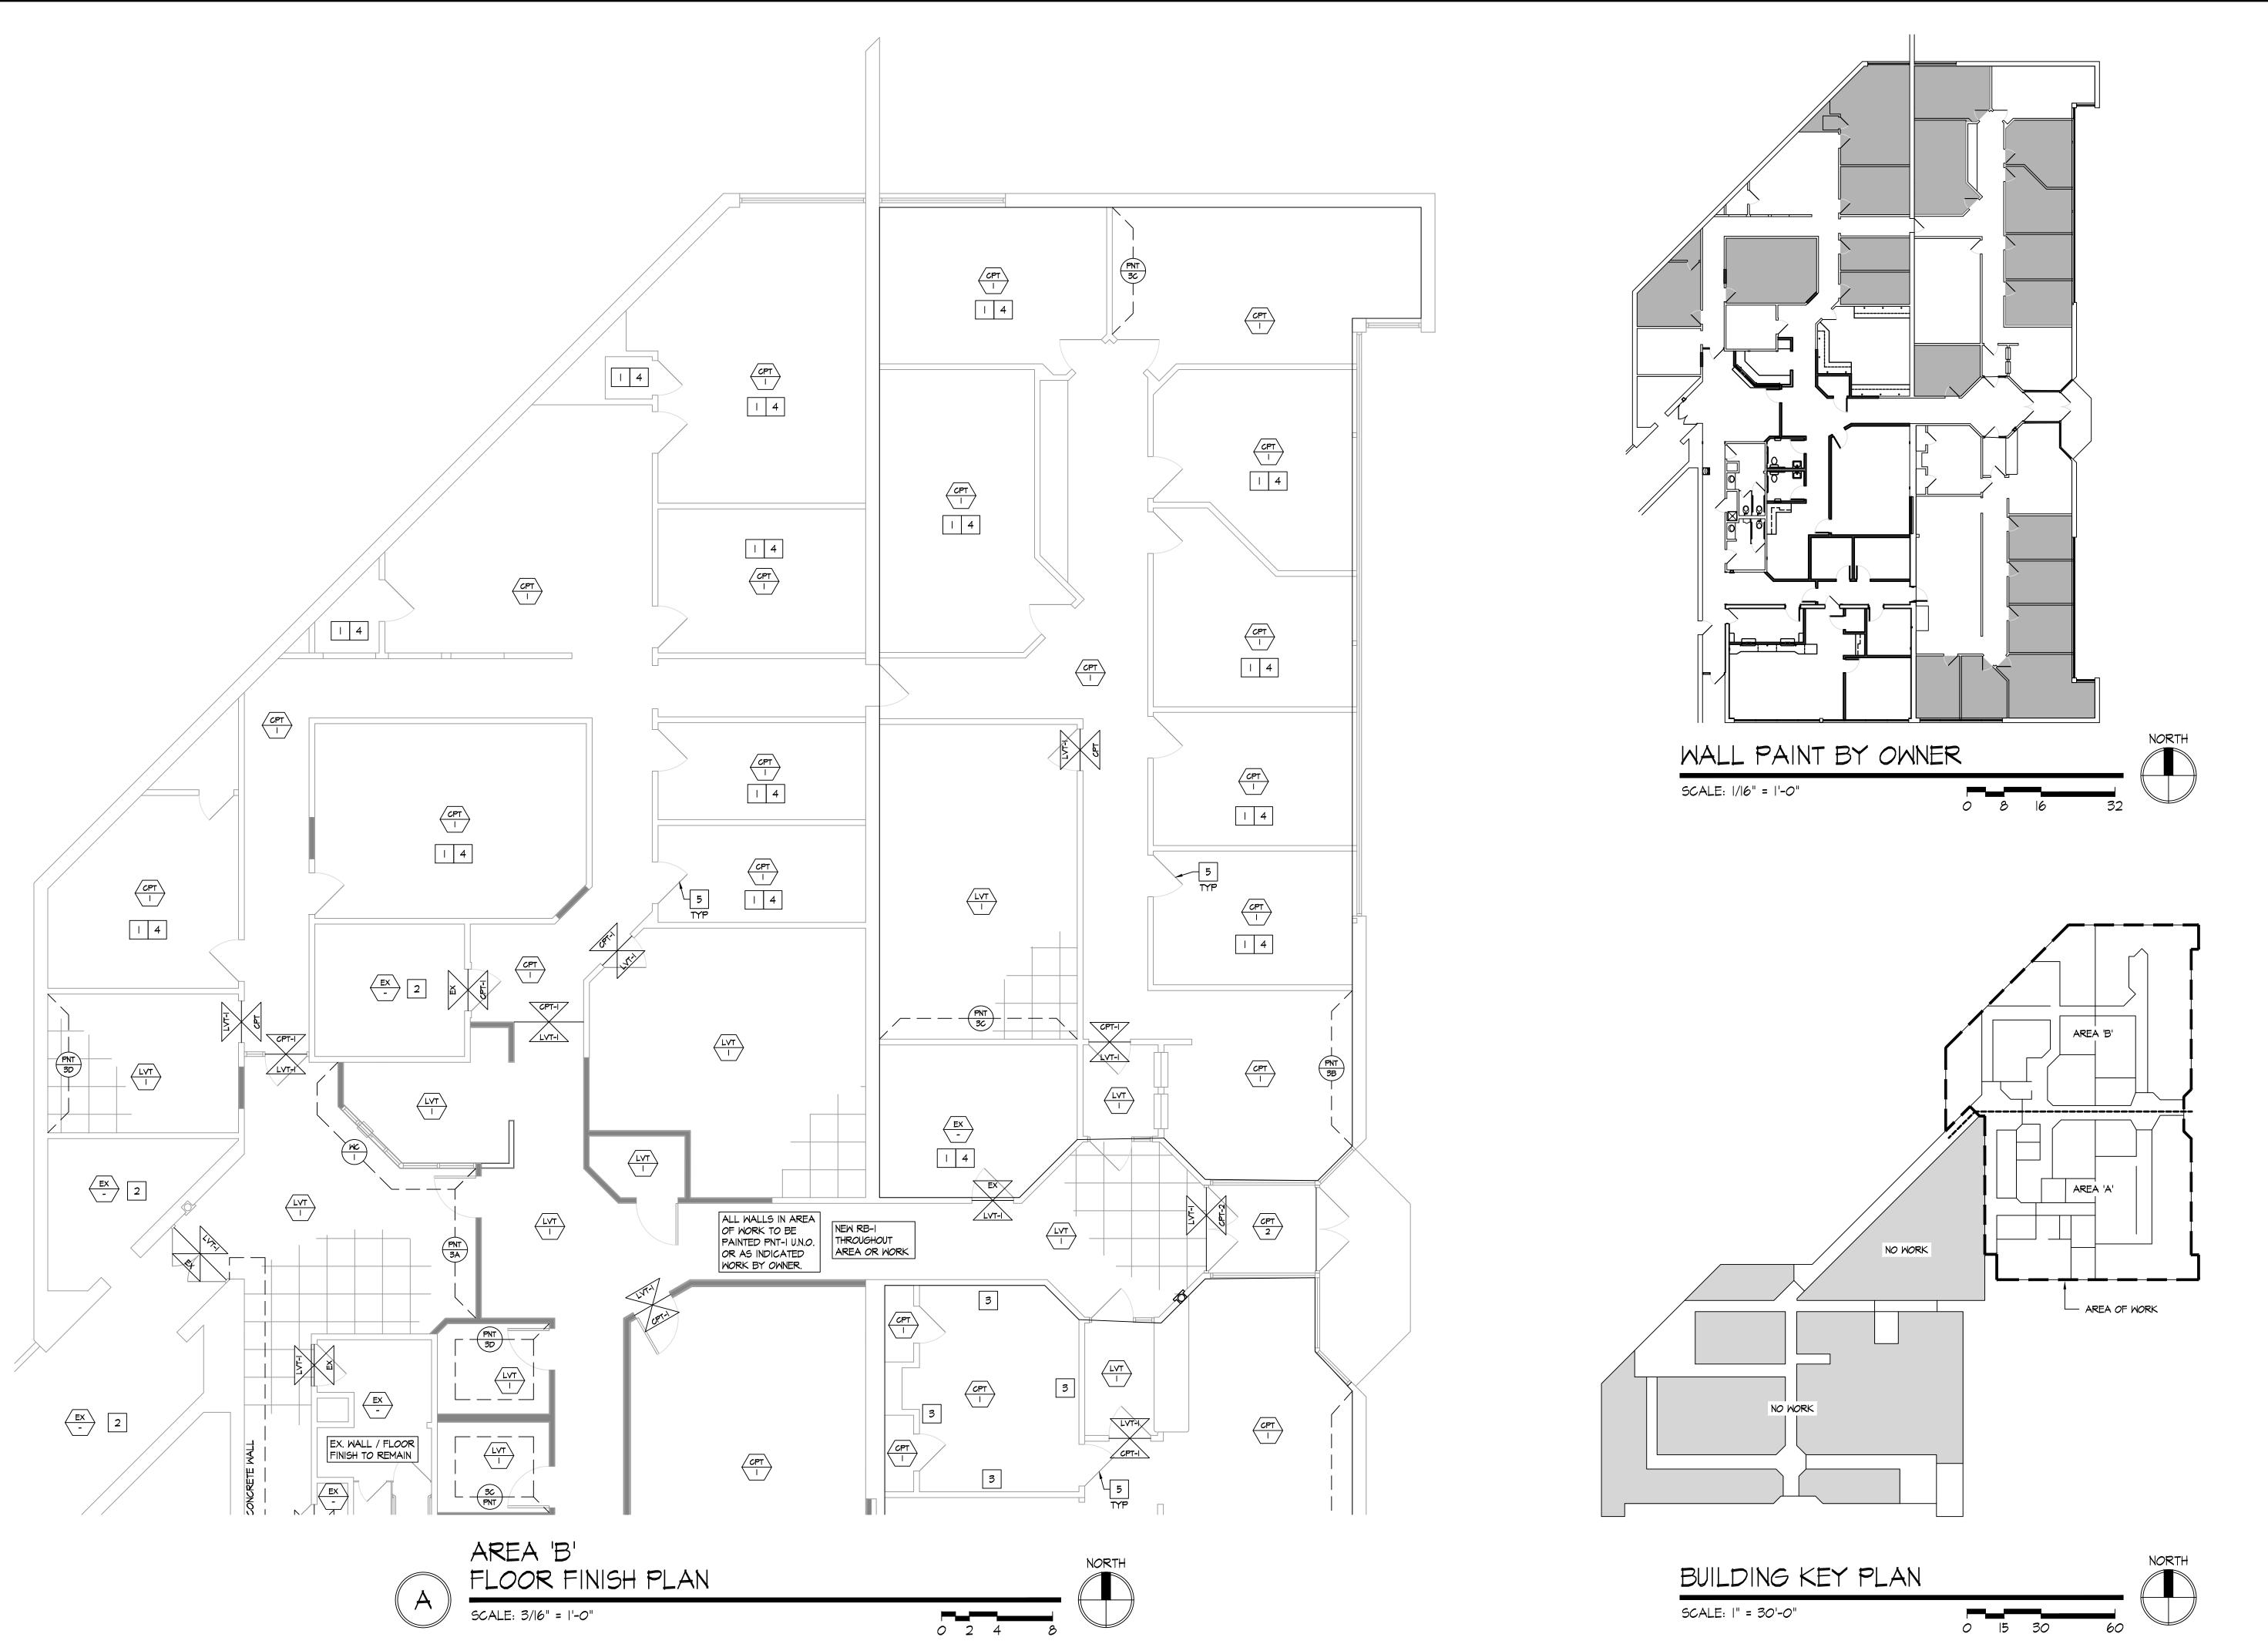
Woods Drive


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Sheet Title AREA 'A'





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City of Moraine Municipal Building

A200 Dryden Road

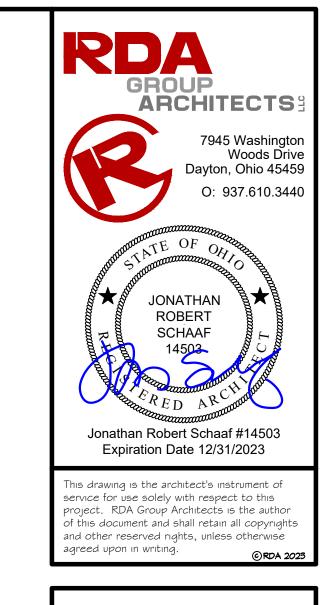Moraine, OH 45439

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Date


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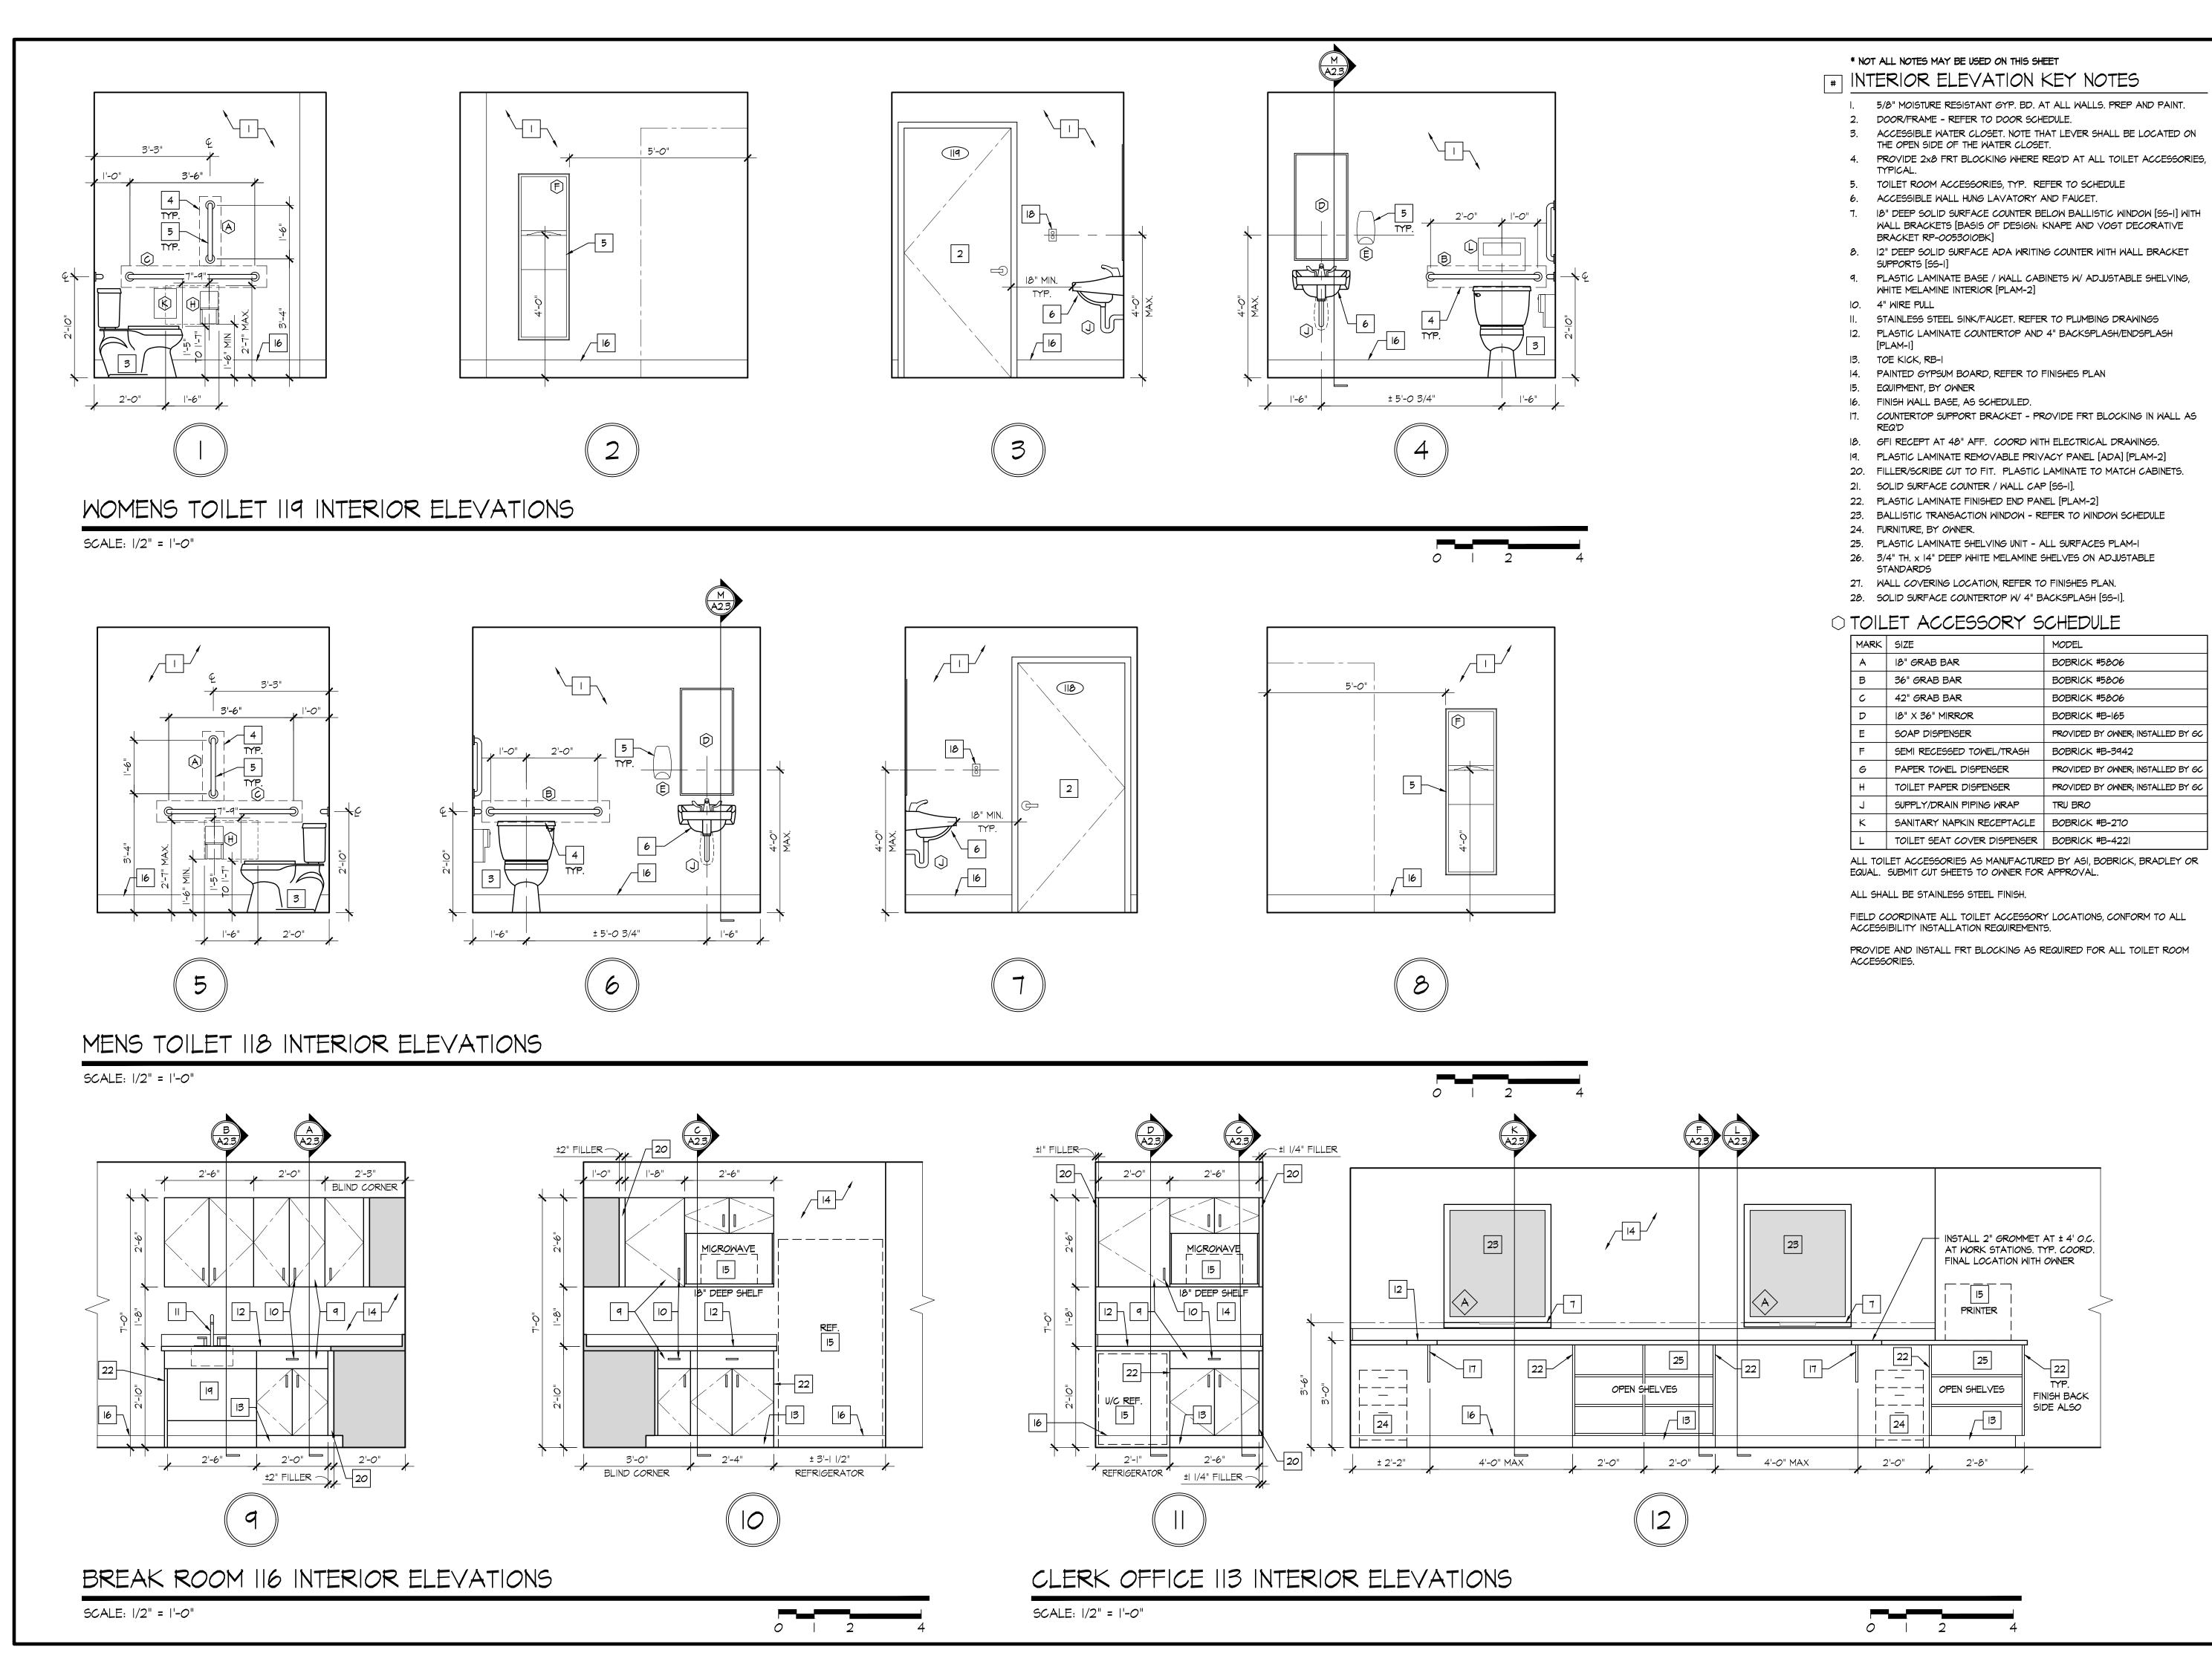
Sheet Title

AREA 'B'
FINISHES PLAN

Sheet Number

8.1A



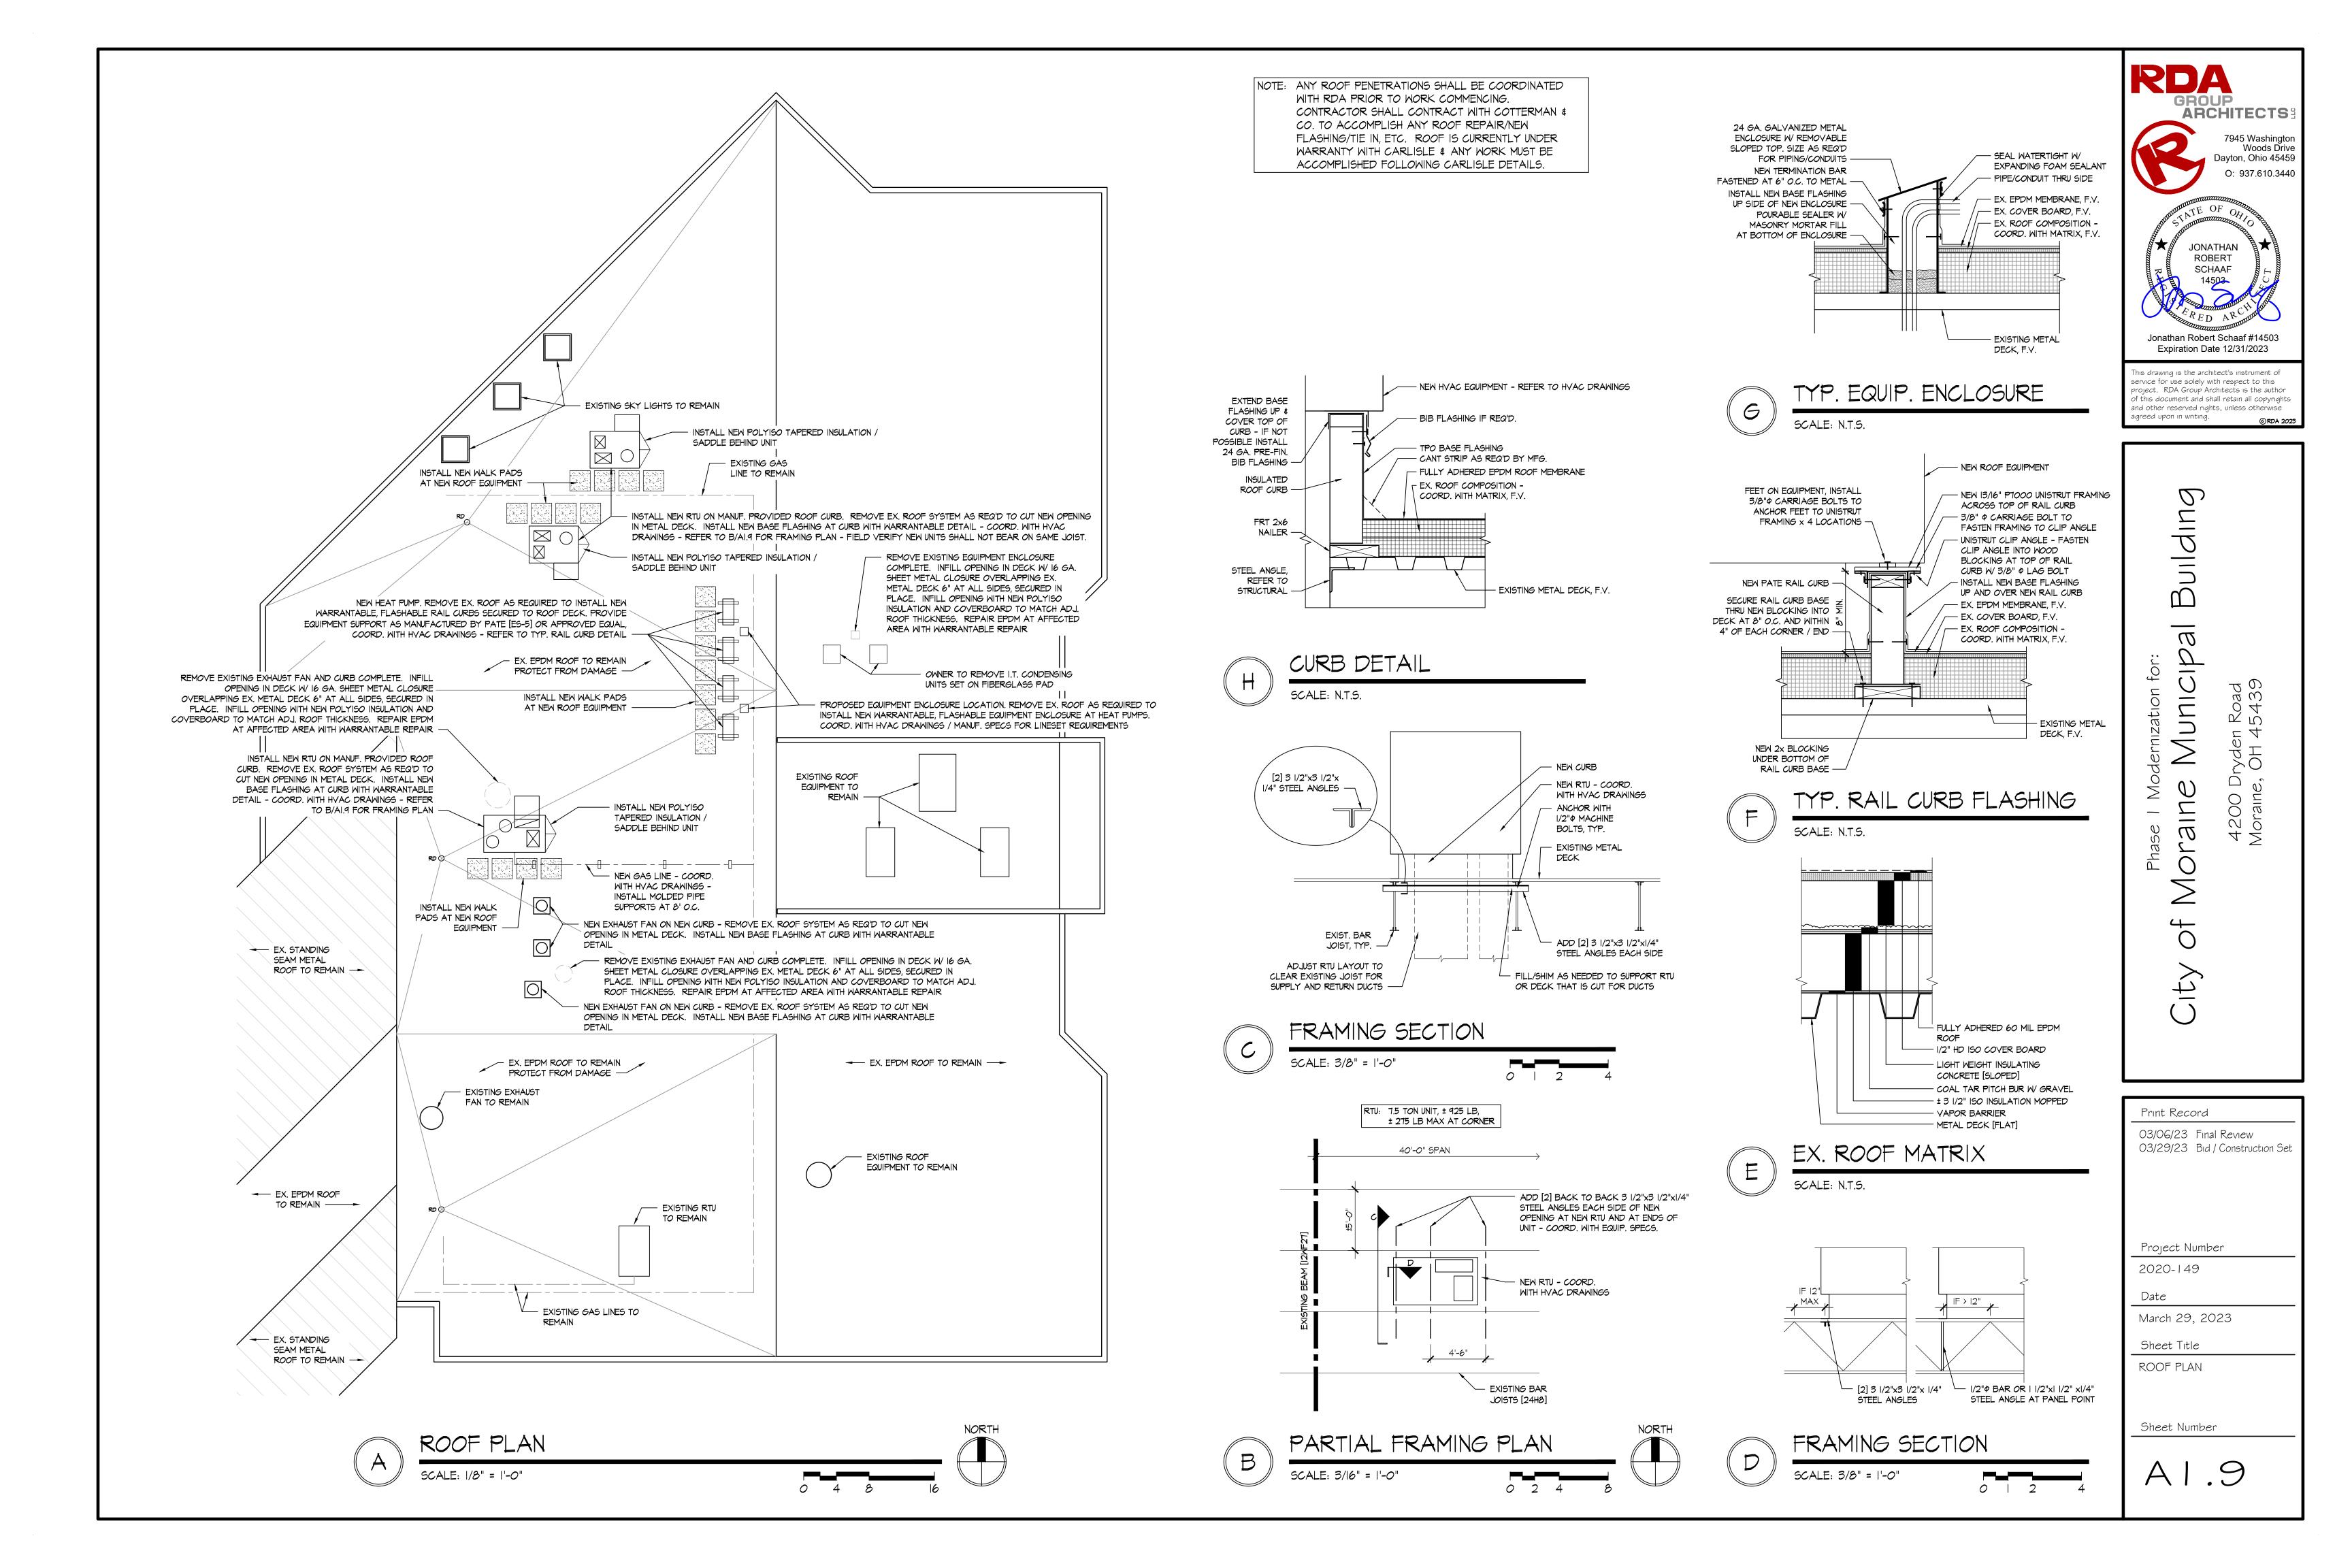

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Dayton, Ohio 45459
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JONATHAN
ROBERT
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14503

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oraine, OH 45439

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Project Number

2020-149

Date


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Sheet Title

INTERIOR ELEVATIONS

Sheet Number

A2.1

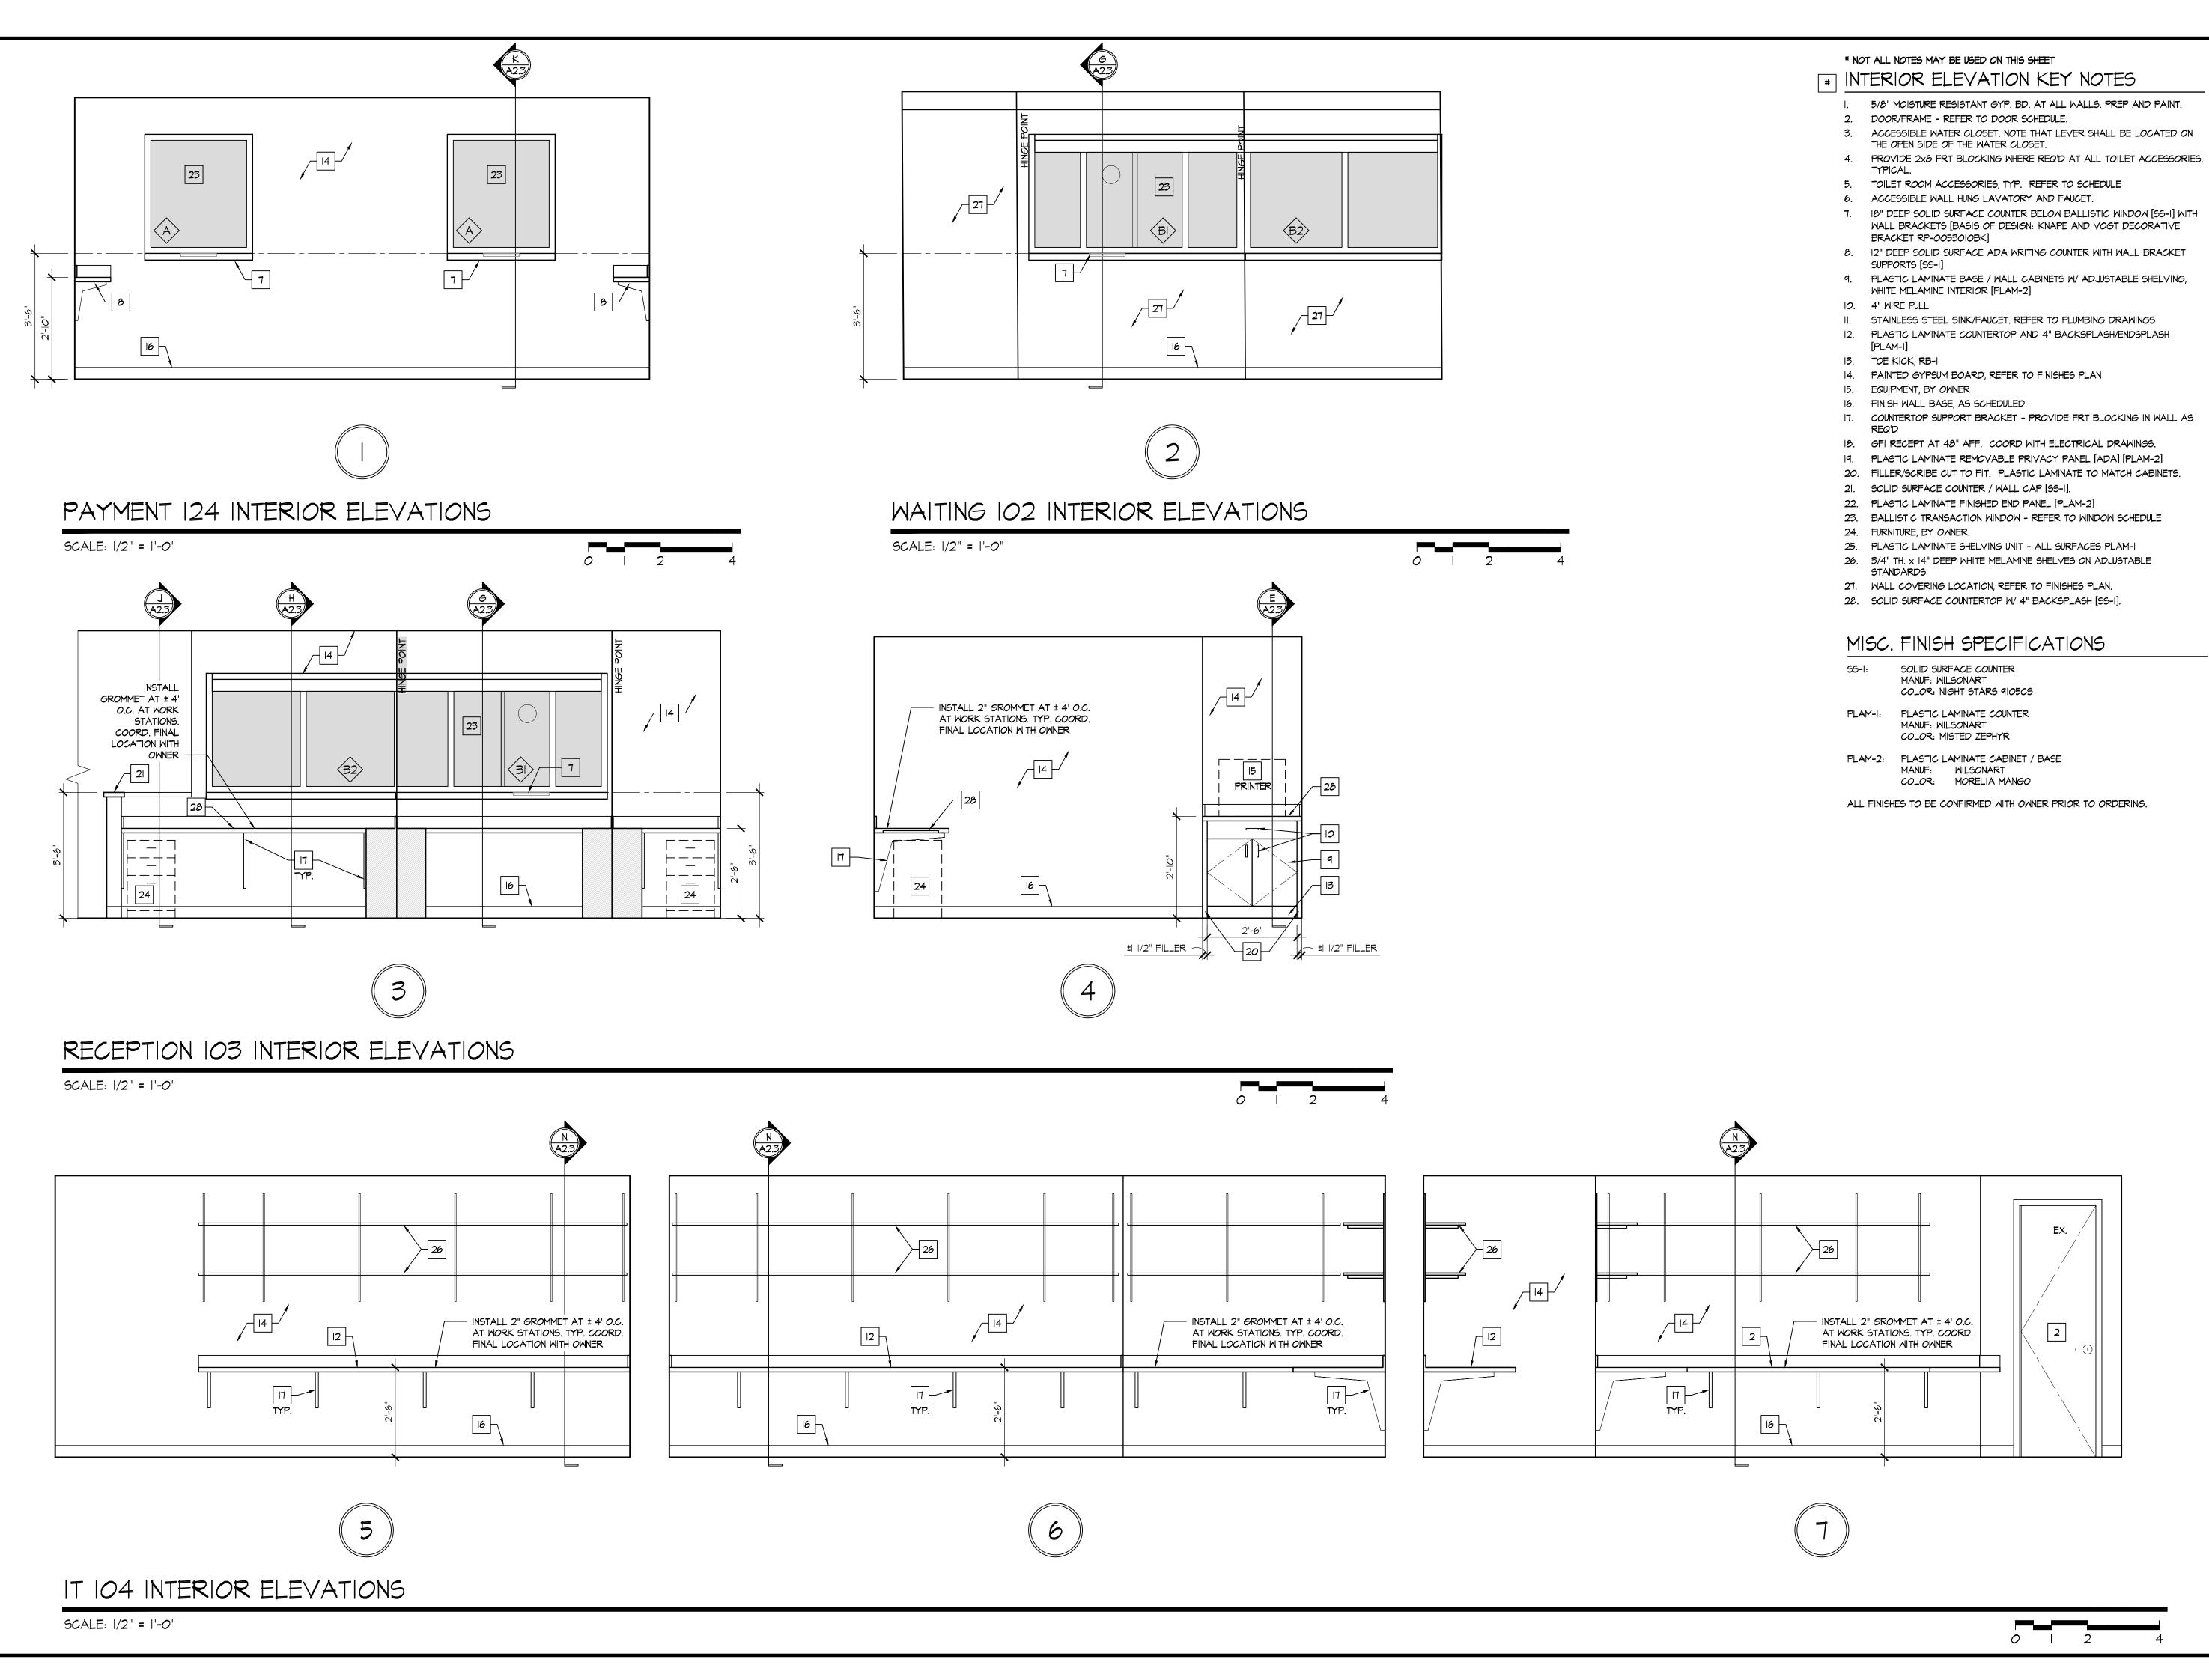

GROUP ARCHITECTS 3 7945 Washington Woods Drive Dayton, Ohio 45459

Woods Drive Dayton, Ohio 45459
O: 937.610.3440

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Phase I Modernization for:

of Moraine Municipal Building

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Date

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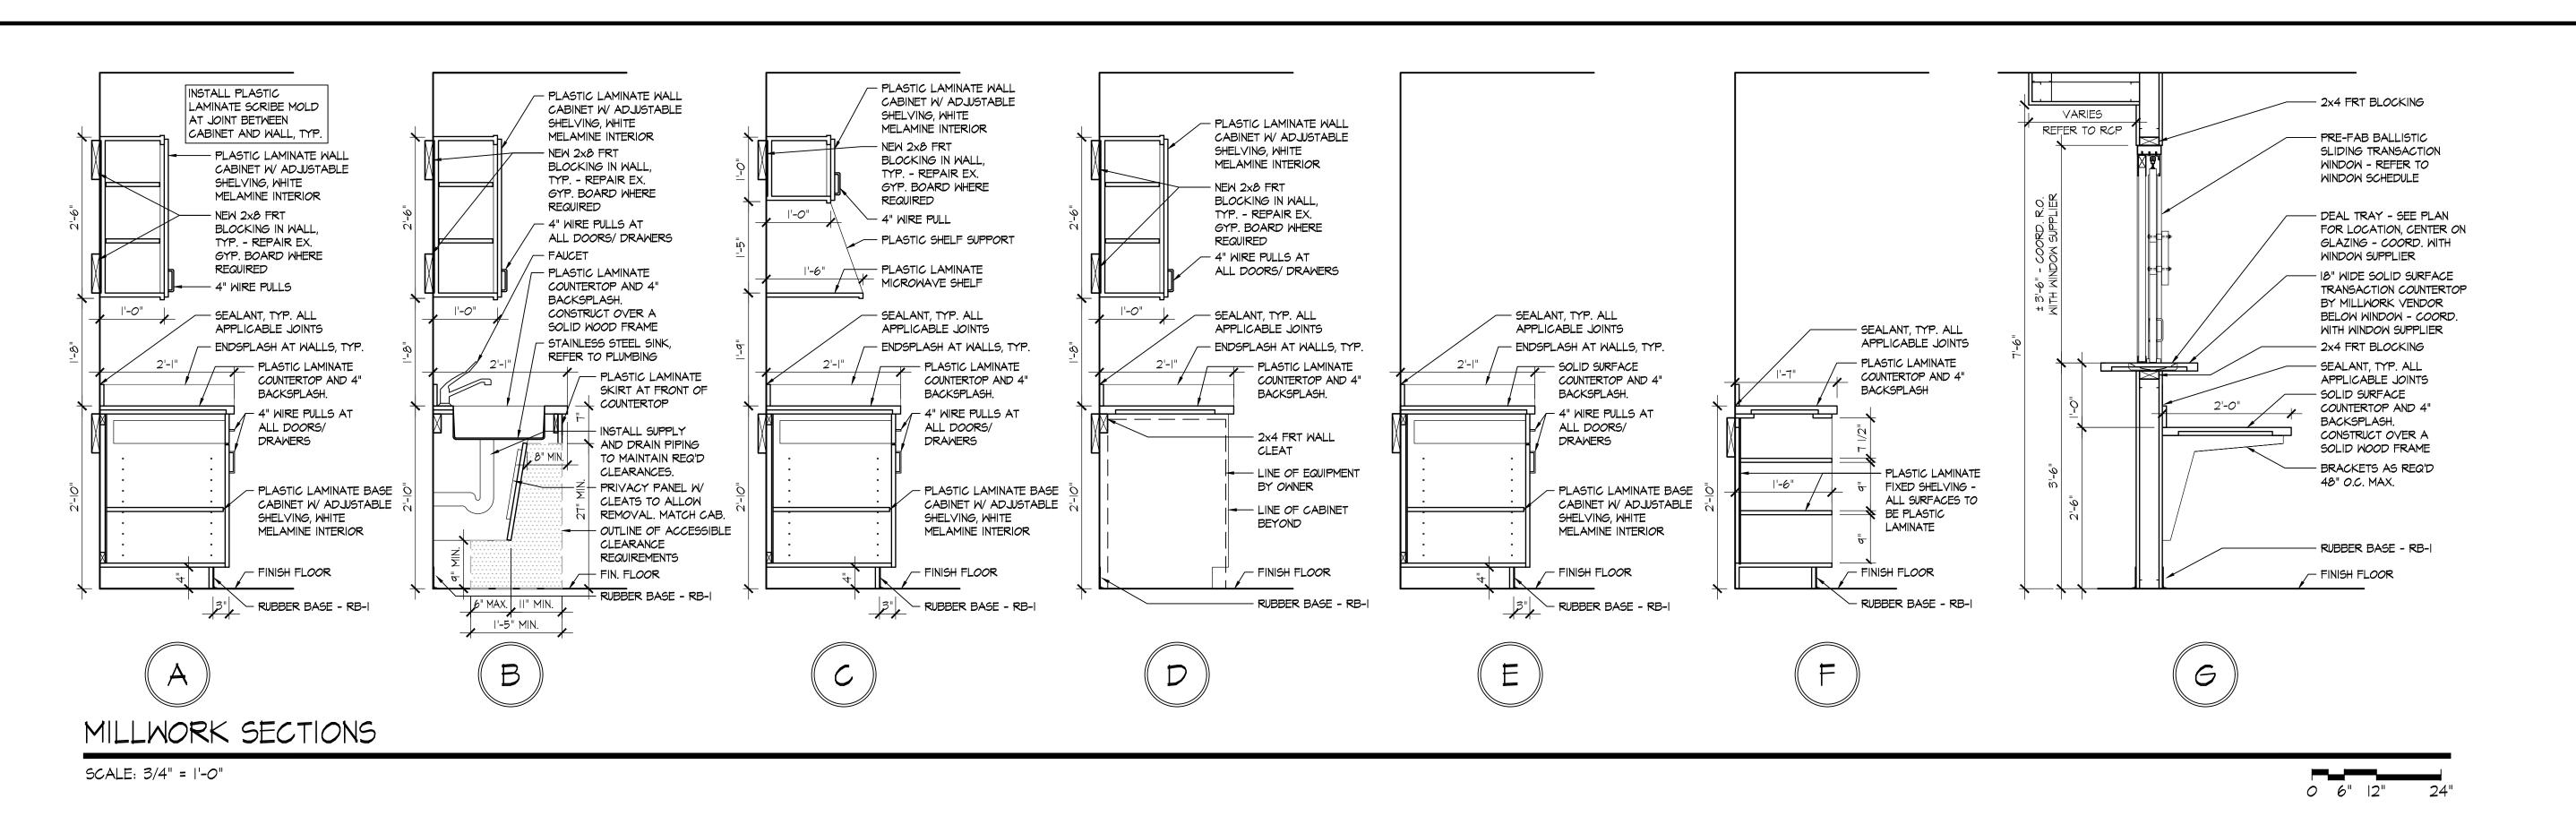
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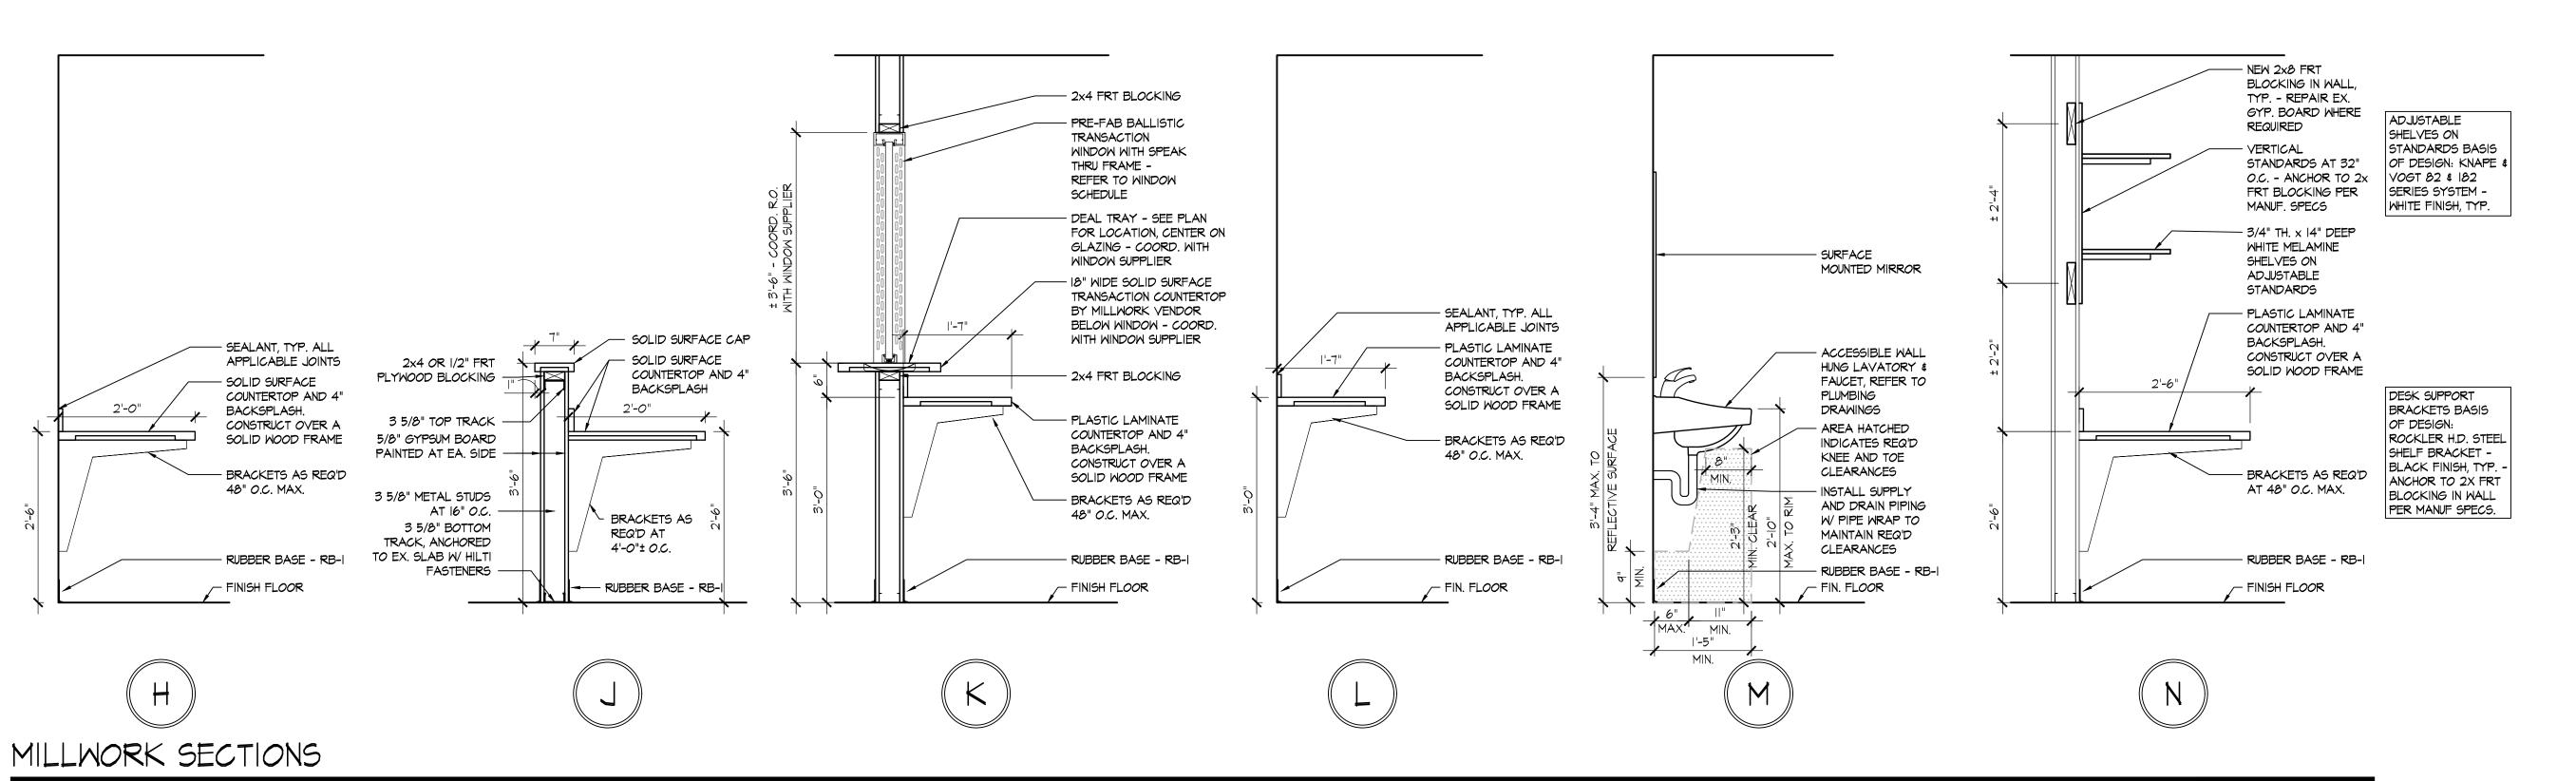
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INTERIOR ELEVATIONS


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A2.2





SCALE: 3/4" = 1'-0"



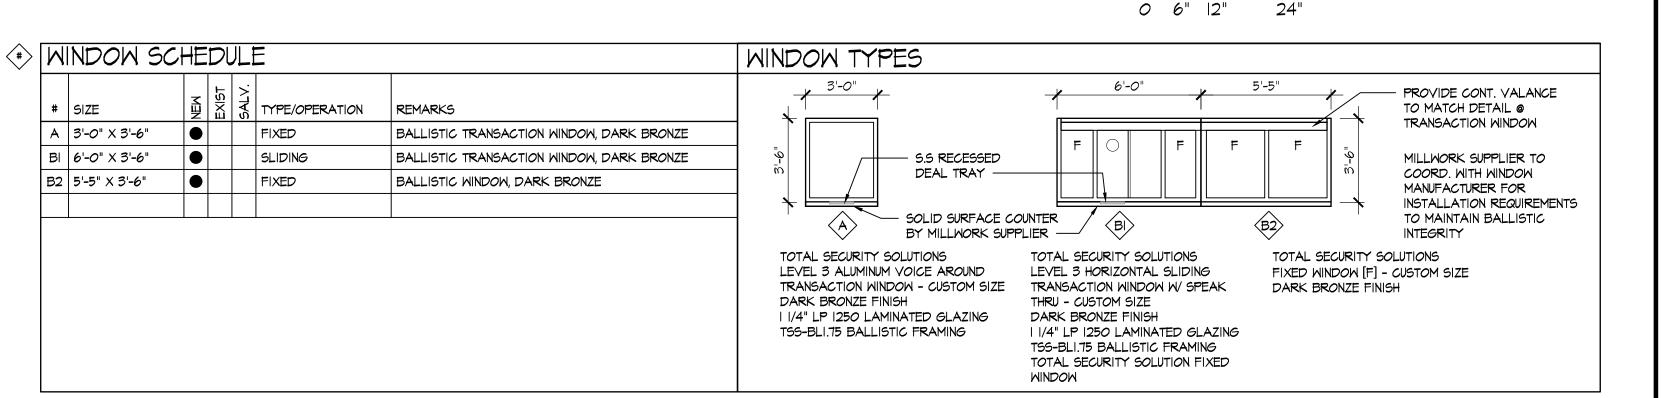

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# City of Moraine Municipal Building

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2020-149


Date

March 29, 2023

Sheet Title

MILLWORK SECTIONS

Sheet Number

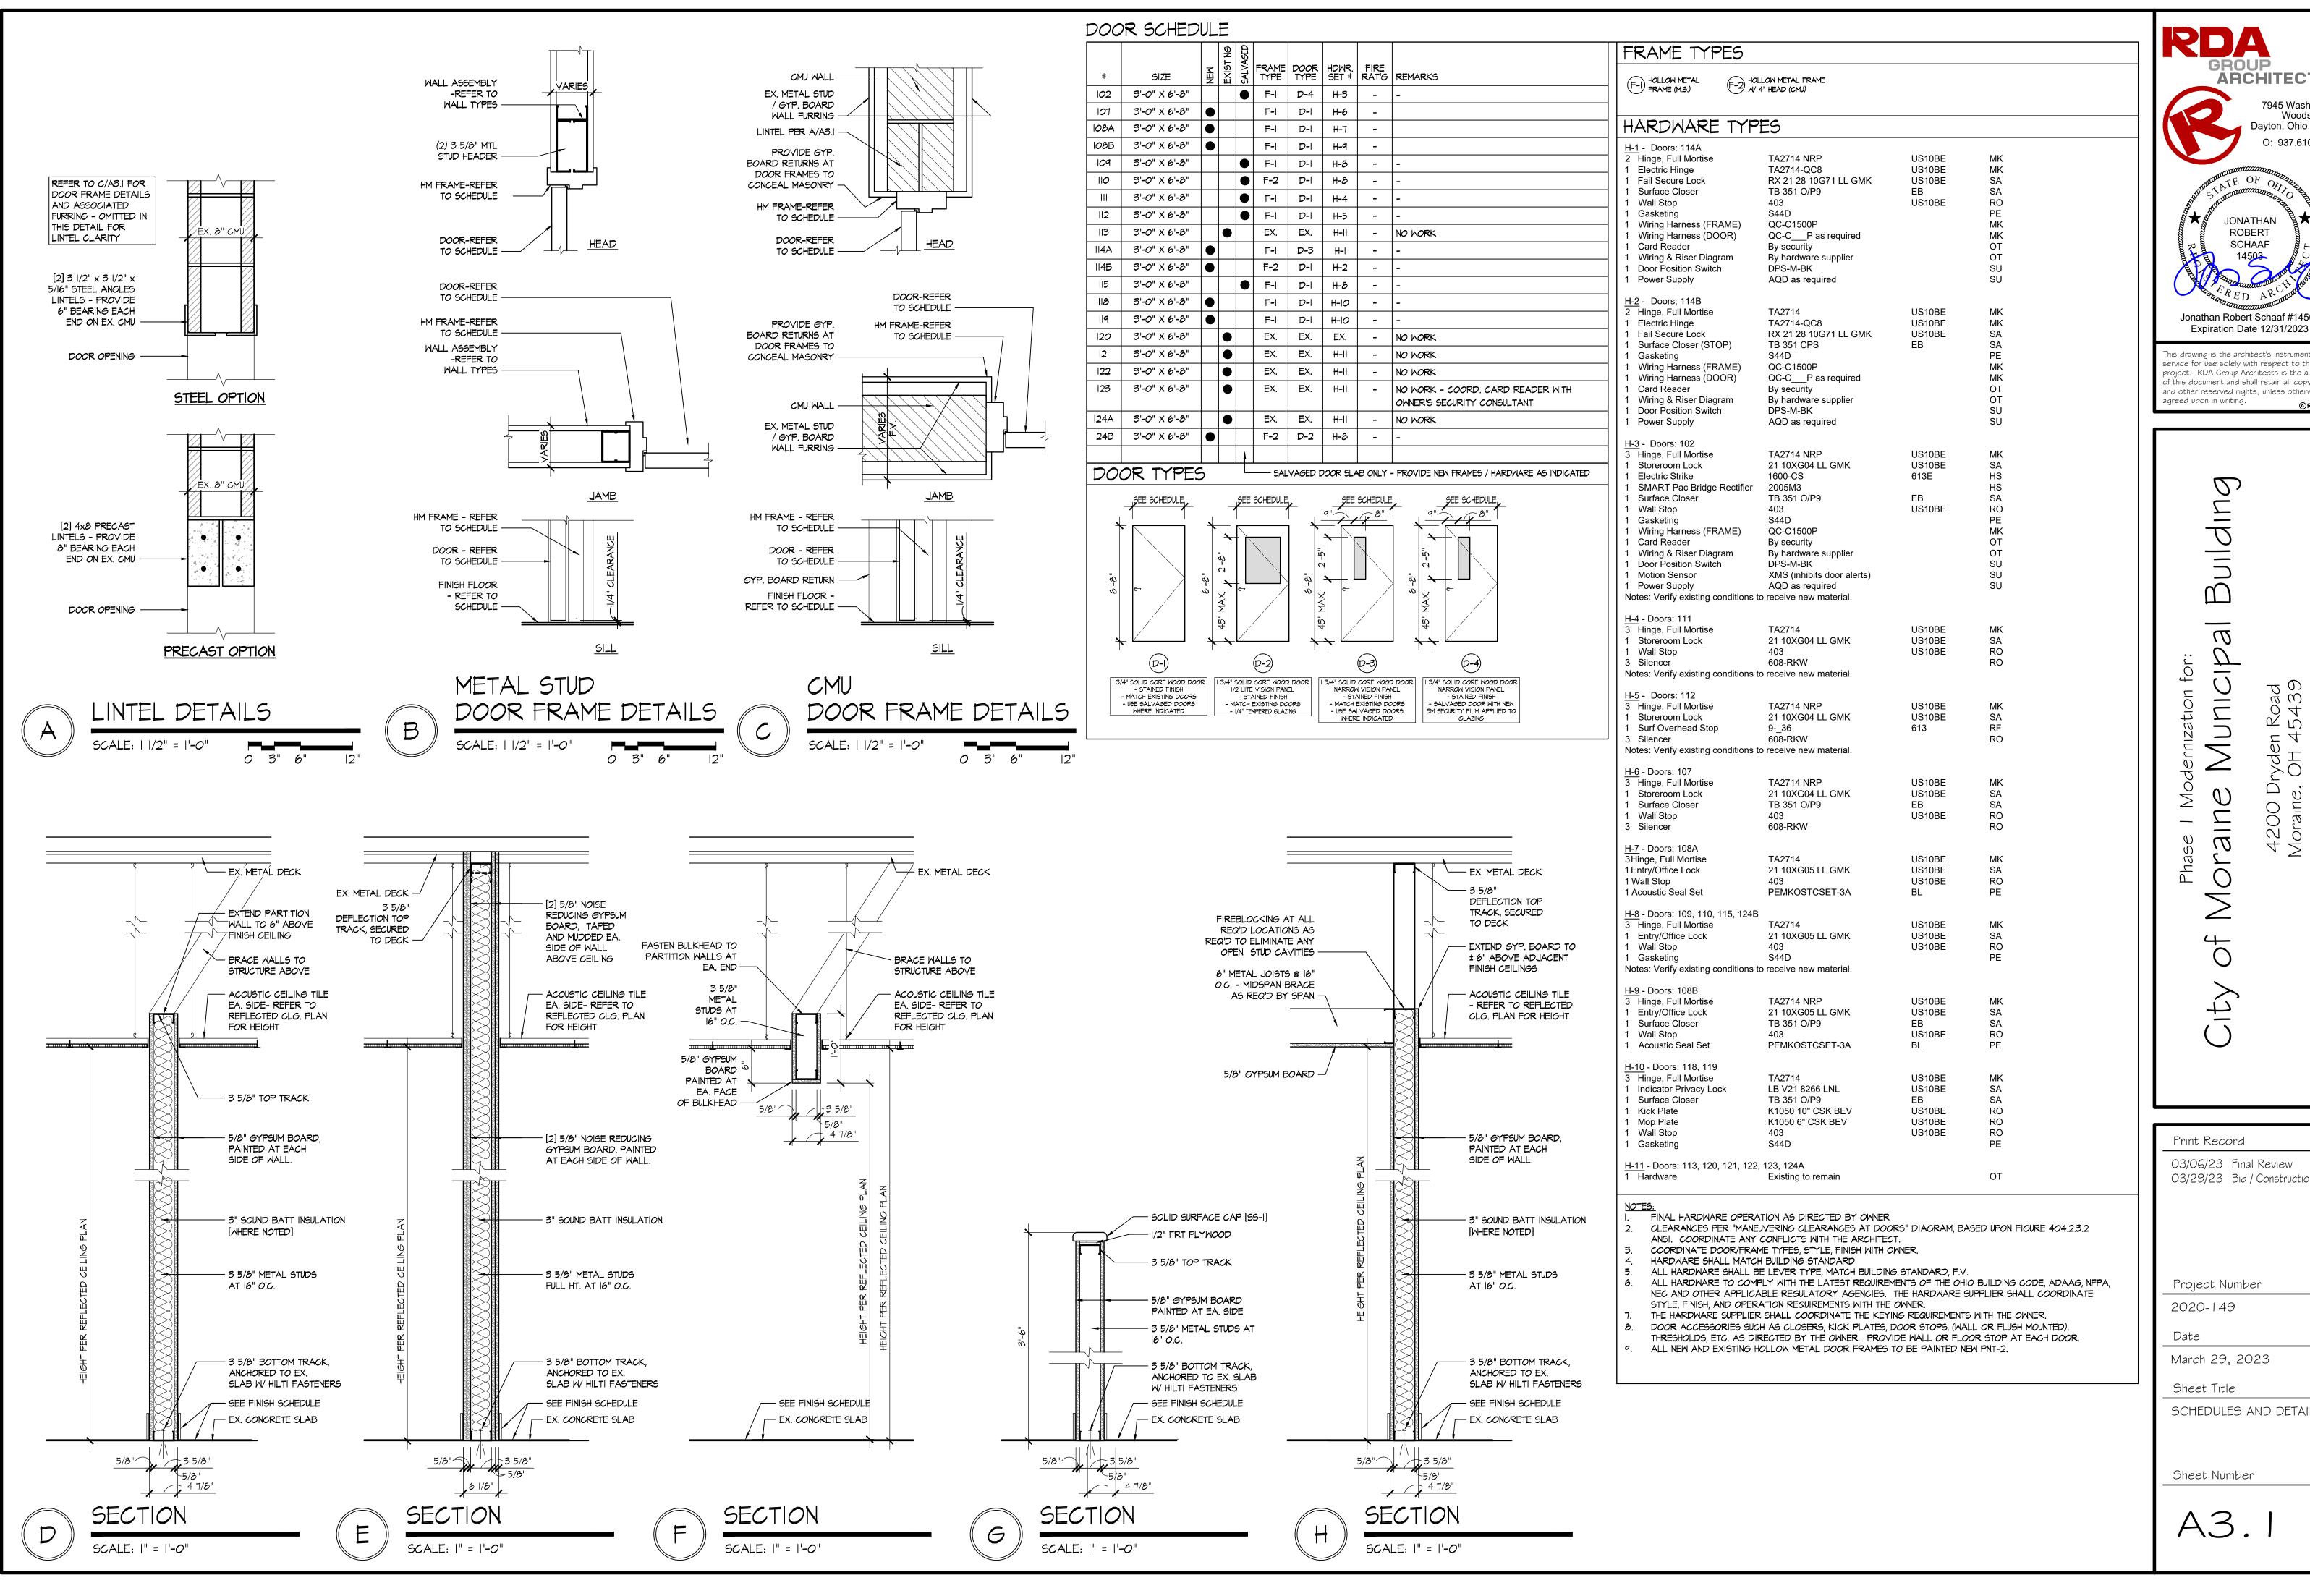

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Project Number

March 29, 2023

SCHEDULES AND DETAILS

Sheet Number

A3.

### SPRINKLER GENERAL NOTES

SPRINKLER SYSTEM DESIGN SHALL BE BASED ON LIGHT HAZARD REQUIREMENTS UNLESS OTHERWISE INDICATED. SPRINKLER SYSTEM IS LIMITED TO A MAXIMUM OF 225 SQ. FT. PER SPRINKLER, 1500 SQ. FT. AREA OF OPERATION ANS 165 DEGREE TEMPERATURE RATED HEAD. CONTRACTOR SHALL VERIFY SAFETY MARGIN REQUIRED FOR WATER SUPPLY WITH LOCAL AUTHORITY HAVING JURISDICTION.

- CONTRACTOR SHALL VERIFY ALL EXISTING SERVICES AND/OR ANY SERVICES INSTALLED UNDER SEPARATE CONTRACT BEFORE STARTING ANY WORK THAT MAY PERTAIN TO SAME SERVICE.
- THIS CONTRACTOR SHALL COORDINATE THE LOCATION OF ALL HORIZONTAL AND VERTICAL PIPING WITH ALL OTHER TRADES AND SHIFT LOCATION WHERE REQUIRED.
- WHEN CAPACITY OF TRAPPED SECTION OF PIPE IS (5) GALLONS OR LESS, AUXILIARY DRAIN SHALL CONSIST OF A 1" NIPPLE AND CAP OR BRASS PLUG. WHEN CAPACITY OF TRAPPED SECTION OF PIPE EXCEED (5) GALLONS, THE AUXILIARY DRAIN SHALL CONSIST OF A 1" VALVE COMPLETE WITH FIXED PIPING TO COMBINATION DRAIN PIPING AT STANDPIPES WHICH SHALL DRAIN TO AN
- THIS CONTRACTOR SHALL BE RESPONSIBLE FOR TESTING OF EXISTING SERVICES WHEN NEW CONNECTIONS ARE MADE TO SAME.
- SPRINKLER CONTRACTOR SHALL PROVIDE WATER FLOW TEST AND SUBMIT RESULTS TO ENGINEER. TEST RESULTS SHALL INDICATE TIME AND LOCATION OF TEST. FLOW RATE OF TEST SHALL EXCEED FLOW REQUIRED FOR SYSTEM BY A MINIMUM OF 50% UNLESS OTHERWISE APPROVED BY ENGINEER.
- NEW SPRINKLERS IN FINISHED CEILING AREAS SHALL BE DECORATIVE CONCEALED PENDENT TYPE WITH COVER PLATE ASSEMBLY TO MATCH
- ALL WORK SHALL BE IN ACCORDANCE WITH NFPA 13 AND FACTORY MUTUAL GUIDELINES. ALL NEW PIPING SHALL BE THREADED SCHEDULE 40 STEEL CONFORMING TO ASTM A53 STANDARDS WITH CAST IRON FITTINGS MANUFACTURED ACCORDING TO ANSI B16.4 FROM MATERIAL CONFORMING TO ASTM A126, CLASS B. NIPPLE CONNECTION AT EXISTING SPRINKLER FITTING SHALL NOT EXCEED 4" IN LENGTH AS REQUIRED BY NFPA 13 - SECTION 5-13.20. NEW SPRINKLERS, ESCUTCHEONS, PIPE HANGERS, ECT. SHALL MATCH EXISTING. VERIFY EXACT CONDITIONS AT JOB SITE.
- ALL WORK SHALL BE IN ACCORDANCE WITH NFPA 13 AND OWNER'S INSURANCE CARRIER'S GUIDELINES. ALL NEW PIPING 2" AND UNDER SHALL BE THREADED SCHEDULE 40 STEEL CONFORMING TO ASTM A53 STANDARDS WITH CAST IRON FITTINGS MANUFACTURED ACCORDING TO ANSI B16.4 FROM MATERIAL CONFORMING TO ASTM A126, CLASS B. ALL NEW PIPING 2-1/2" AND OVER SHALL BE ROLL GROOVED SCHEDULE 10 STEEL CONFORMING TO ASTM A135 STANDARDS WITH MALLEABLE IRON OR WROUGHT SEAMLESS STEEL FITTINGS. GROOVED COUPLINGS SHALL PROVIDE FOR AN ALLOWABLE WORKING PRESSURE OF 175 PSI OR FOR SYSTEM REQUIREMENTS IN EXCESS OF THIS FIGURE AS DETERMINED BY JOB CONDITIONS.

### ROOM INDEX

- 100 NOT USED
- 101 ENTRY CORRIDOR 102 WAITING 103 RECEPTION 104 I.T.
- 105 CORRIDOR 106 NOT USED
- 107 STOR.
- 108 CONFERENCE 109 MAYOR OFFICE
- 110 PROSECUTOR
- 111 CLERK STOR.
- 112 I.T. 113 CLERK OPEN OFFICE
- 114 CORRIDOR 115 CONSULT
- 116 BREAK 117 CORRIDOR
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- 116 MEN S
  119 WOMEN'S
  120 WOMEN
  121 JANITOR
  122 MEN
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  124 PAYMENTS
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- 125 CITY MANAGER
  126 CITY MANAGER RECEPTIONIST
  127 H.R.
  128 STORAGE
  129 CLERK OF COUNCIL STORAGE
  130 CORRIDOR
- 130 CORRIDOR
  131 CLERK OF COUNCIL
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  133 COUNCIL CONFERENCE ROOM
  134 A.V.
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  136 CORRIDOR

Project Numbers

<u>m</u>

2020-149/6614

Date

Print Record

07/29/22 FINAL CHECK SET

03/06/23 FINAL REVIEW

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group architects

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JANUARY 28, 2022

Sheet Title

SPRINKLER - PARTIAL FIRST FLOOR PLANS

Sheet Number

FP1-1

3/8/2023 WEICHELMAN 4:28:34 PW 3/8023 4:28:34 PW H:\66003\6614\6614-FP1 Pyright 2023 © Helmig Lienesch

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### DRAIN SCHEDULE

C-CAST IRON

**OUTLET TYPES OPTIONS OPTIONS** A-NO HUB A-FLANGE J-HINGED COVER **B-CLAMP DEVICE B-THREAD** K-SOLID TOP C-SIDE OUTLET C-SEDIMENT BUCKET L-POLISHED NICKEL **D-EXTENSION BRONZE TOP** TOP TYPES E-DECK CLAMP F-BEARING PAN A-NICKEL BRONZE G-TRAP PRIMER TAPPING B-POLISHED BRASS H-DUCTILE GRATE

**ZURN** OUTLET TOP SERIES NO. SIZE TYPE TYPE OPTIONS A A,B,C,L

I-SQUARE GRATE

PROVIDE A SURE SEAL DRAIN TRAP ON ALL FLOOR DRAINS TO MAINTAIN THE TRAP SEAL AS REQUIRED.

### PLUMBING EQUIPMENT DATA <

### A <u>TEMPERING VALVE</u>

ASSE 1070 LISTED SINK TEMPERING VLAVE TO LIMIT WATER TEMPERATURE TO 110 DEG F. WATTS "USG-6-M2-3/8" UNDERSINK GUARDIAN THERMOSTATIC

### PLUMBING FIXTURE SCHEDULE

REF	DESCRIPTION	MTG HGT	SUPPL HOT	COLD	WASTE	TRAP	VENT
A1	WATER CLOSET-FS-TANK - ADA SEE SPECIFICATIONS BELOW			3/4	3	INT	1-1/2
C1	LAVATORY-WH-ADA SEE SPECIFICATIONS BELOW	34	1/2	1/2	1-1/2	1-1/2	1-1/2
C2	SINK - COUNTERTOP SEE SPECIFICATIONS BELOW	COUNTER	1/2	1/2	1-1/2	1-1/2	1-1/4

### WATER CLOSET - FLOOR SET - TANK - ADA - 1.28 GALLON FLUSH

- A. Vitreous china, 16-1/2" high elongated bowl, close-coupled tank with left side trip lever in Room 119 & right-side lever trip in Room 118 and 1.28 gallon flush -American Standard "Cadet Pro Right Height" #215AA.104 Kohler "Highline" #K-
- Seat heavy duty solid plastic, white, elongated, open front, cover, stainless steel posts, washers and nuts - Bemis #1950ST; Beneke #521HPSS; Centoco

### LAVATORY - WALL HUNG - DUAL CONTROL - GRID - ADA

- A. Vitreous china, 20" X 18" front overflow, backsplash and faucet holes on 8" centers (for concealed arms support) - American Standard "Lucerne" #0356.015; Kohler "Kingston" #K-2006-0.
- B. Faucet dual control combination with compression type valves with renewable seats or ceramic disc valve cartridges, 4" spout, 8" centers, metal lever handles, - T & S Brass #B-2990; American Standard "Heritage" #7298-152.002; Chicago #404A modified with #369 lever handles; Kohler "Triton II" #K-7443-K/K-16012-4;
- Offset drain plug cast brass body with integral open grid strainer, offset drain assembly, 1-1/4" tailpiece and chrome finish - American Standard #7723.018; BrassCraft #0702; Chicago #337; Zurn #Z-8746.
- D. Trap cast brass P-trap with 17 gauge tubing drain to wall, 1-1/4" inlet and 1-1/2" outlet, cleanout plug, escutcheon and chrome finish - Zurn #Z-8701-9; Kohler #K-8999-CP; McGuire #8902C.
- E. Supplies angle type with loose key stop, 3" nipple, 3/8" O.D. flexible tube riser, escutcheon and chrome finish - Zurn #Z-8800-LR-LK; McGuire #165LK.
- F. Handicapped lavatory P-Trap, hot and cold angle stop assemblies shall be insulated with a fully molded vinyl cover. Abrasion exterior vinyl cover shall be smooth and have 1/8" minimum wall over cushion foam insert. Fasteners shall remain substantially out of sight. Zurn #Z-8946-3-NT; PLUMBEREX "Pro-Extreme" #X4444: Dearborn #ADA100.
- G. Carrier rectangular tube upright supports with steel plate base and concealed arms. Zurn #Z1231

### C2 <u>SINK - STAINLESS STEEL - SINGLE COMPARTMENT - SWING SPOUT - BASKET</u>

- A. Self-rimming, 18-gauge, type 302 (18-8) nickel bearing stainless steel, 15" X 18" X 7-1/2" with sound deadening and three (3) faucet holes - Elkay "Lustertone" #LR-1517; Just "Stylist" #SL-1815-A-GR.
- B. Faucet single lever handle with replaceable washerless cartridge, swing spout, 8" centers, aerator and chrome finish - American Standard "Reliant + " #4205.000; Kohler "Coralais" #K-15171-F-CP; Symmons "Symmetrix" #S-23; T&S Brass Co. B-2731.
- C. Drain stainless steel crumb cup strainer with removable basket, rubber seat stopper and 1-1/2" tailpiece - Dearborn #10T; Elkay #LK-99; Just #JB99; Engineered Brass Co. #SB8D; Zurn Z-8741.
- D. Trap Cast brass P-trap with 17-gauge tubing drain to wall, 1-1/2" inlet and outlet, cleanout plug, escutcheon and chrome finish - Brass Craft #0030; Crane #8-5260; Dearborn #510; Kohler #K-9000; McGuire #8912; Zurn #Z-8702-9.
- E. Supplies angle type with loose key stop, 3" nipple, 3/8" O.D. flexible tube riser, escutcheon and chrome finish - Brass Craft #SR1512AC; McGuire #165LK; Zurn #Z-8800-XL-LR-LK.

### PLUMBING LEGEND

----- COLD WATER SUPPLY ————— HOT WATER RETURN — 110° SOIL AND/OR WASTE CLEANOUT - FLOOR OR GRADE ROOM NUMBER DESIGNATION DESIGNATES REFERENCE TO PLUMBING NOTES BALL VALVE

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### PLUMBING GENERAL NOTES THE CONTRACTOR SHALL COORDINATE THE LOCATION OF ALL HORIZONTAL

THE CONTRACTOR SHALL BE RESPONSIBLE FOR TESTING OF SANITARY, AND WATER SYSTEMS. TESTING SHALL BE PER CODE AND LOCAL INSPECTION AGENCY REQUIREMENTS.

AND VERTICAL PIPING WITH ALL OTHER TRADES AND SHIFT LOCATION WHERE

THE CONTRACTOR SHALL VERIFY ALL SERVICES AND THEIR INVERTS.

FLOOR DRAIN

- VERIFY ALL FIXTURE AND EQUIPMENT LOCATIONS WITH ARCHITECTURAL DRAWINGS.
- THE CONTRACTOR SHALL VERIFY PLUMBING FIXTURE MOUNTING HEIGHTS WITH ARCHITECT / ARCHITECTURAL DRAWINGS. FIXTURES REQUIRING HANDICAPPED ACCESS SHALL BE INSTALLED PER OBBC ACCESSIBILITY
- ALL DOMESTIC HOT AND COLD WATER LINES SHALL BE INSULATED PRESS-FIT OR SOLDERED TYPE "L" COPPER.
- ALL ROOF AND WALL FLASHINGS BY GC.
- PLUMBING CONTACTOR TO REVIEW HVAC DRAWINGS AND NOTES FOR GAS AND CONDENSATE PIPING WORK TO BE COVERED IN PLUMBING CONTRACTOR'S BID PROPOSAL.

## Building

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Sheet Title

PLUMBING - LEGEND, GENERAL NOTES, EQUIPMENT DATA & SCHEDULE

Sheet Number

P0 - 1

### PLUMBING - SHEET INDEX

- PLUMBING LEGEND, GENERAL NOTES, EQUIPMENT DATA & SCHEDULE
- PLUMBING PARTIAL FIRST FLOOR PLANS DEMOLITION & REVISED


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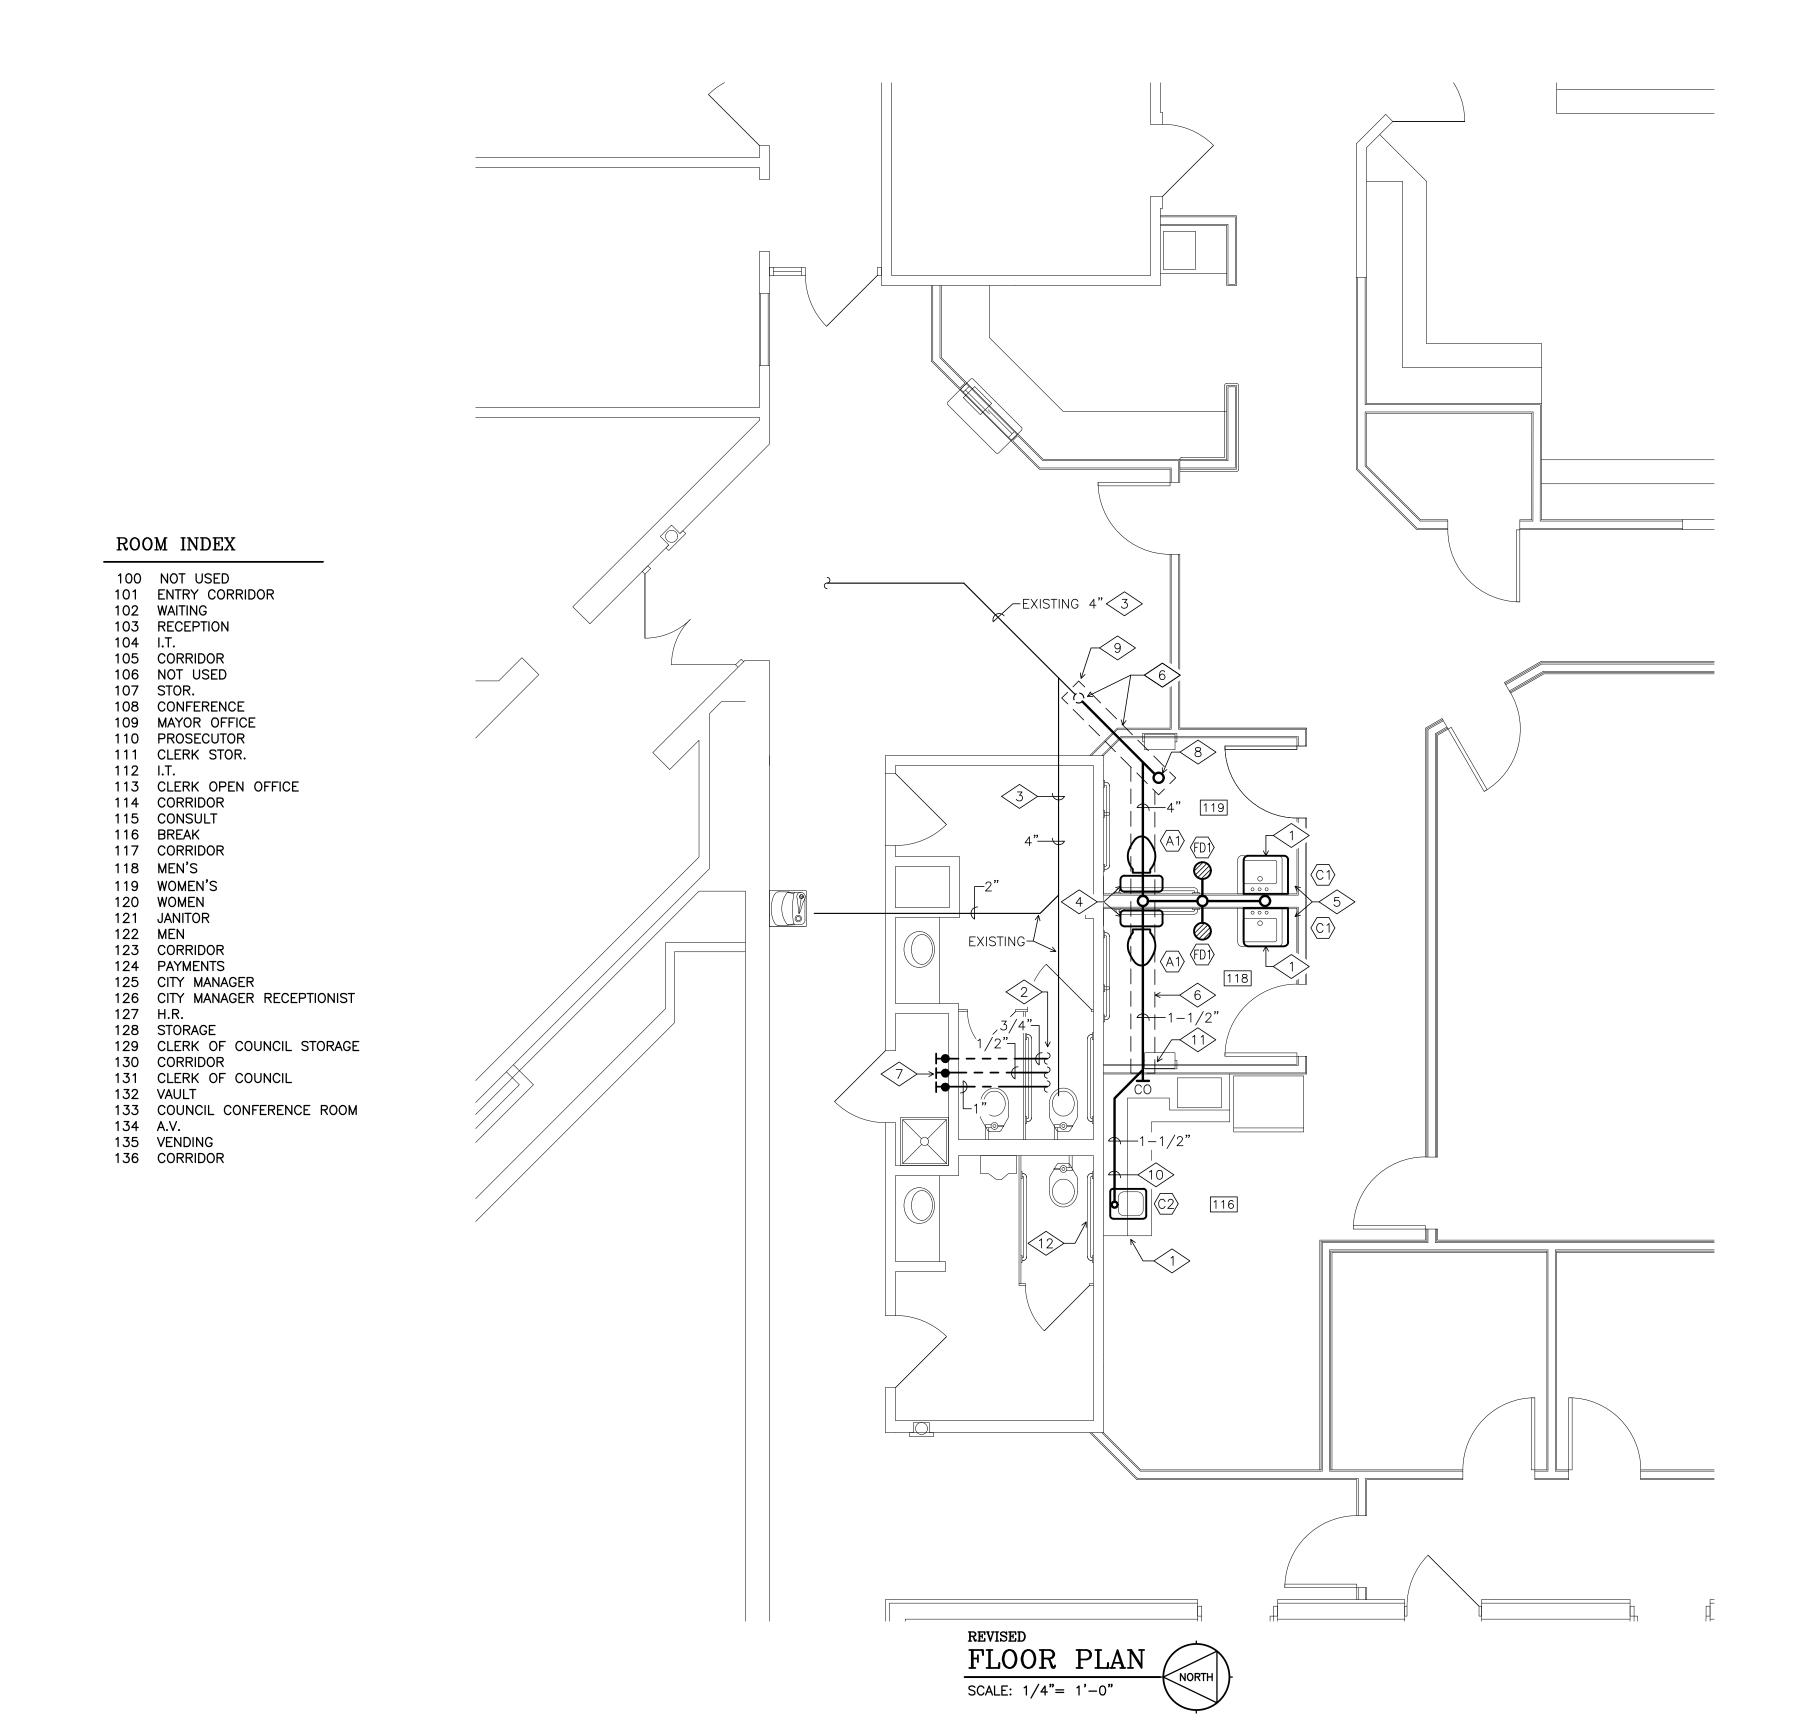
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### PLUMBING NOTES $\diamondsuit$

- 1 PROVIDE AN ASSE 1070 THERMOSTATIC MIXING VALVE. VERIFY EXACT REQUIREMENTS AT JOB SITE. SEE EQUIPMENT DATA.
- THIS PIPING LOCATED ABOVE CEILING AND/OR UNDERSIDE OF STRUCTURE
- 3 THIS PIPING LOCATED BELOW FLOOR OR GRADE.
- 4 EXTEND NEW 3/4" COLD WATER SUPPLY DOWN TO NEW WATER CLOSETS.
- 5 EXTEND 1/2" NEW HOT AND COLD WATER SUPPLIES DOWN TO NEW LAVATORIES. CONNECT NEW ½" HOT WATER RETURN LINE AS REQUIRED.
- 6 MARK UNDERGROUND SANITARY AND SAW CUT CONCRETE SLAB FOR NEW SANITARY CONNECTION TO EXISTING LINE.
- 7 VERIFY LOCATION OF DOMESTIC HOT AND COLD WATER LINES AND CONNECT TO EXISTING. PROVIDE BALL VALVE SHUT OFFS AT MAIN.
- 8 FLOOR CLEANOUT. SEE SPECIFICATIONS.
- 9 REMOVE EXISTING CLEANOUT.
- 10 EXTEND 1-1/2" DRAIN LINE BEHIND CASEWORK BEFORE DROPPING DOWN TO NEW UNDERGROUND SANITARY LINE.
- 11 EXTEND 1-1/4" VENT LINE FROM SINK UP INTO NEW WALL.
- 12 EXTEND NEW 1/2" HOT AND COLD WATER SUPPLIES TO NEW SINK IN BREAKROOM 116.



### SANITARY ISOMETRIC NOT TO SCALE

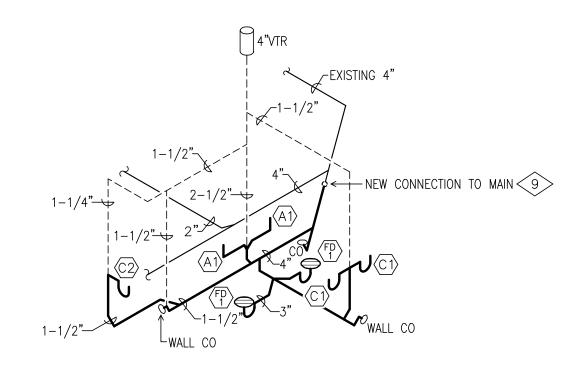

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PLUMBING — PARTIAL FIRST FLOOR PLANS DEMOLITION & REVISED

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P1 - 1

### HVAC NOTES $\Leftrightarrow$

- 1 AFTER ELECTRICAL CONTRACTOR REMOVES ELECTRICAL POWER AND CONTROL WIRING REMOVE EXISTING EXHAUST FAN AND CURB. ROOFING CONTRACTOR SHALL PROVIDE DECK CLOSURE PLATE, INSULATE AND REPAIR ROOF TO MATCH EXISTING.
- 2 EXISTING 3-TON GAS FIRED ROOFTOP UNIT TO REMAIN. RECONFIGURE DUCTWORK AS SHOWN ON SHEET H1-1.
- 3 ROOFING SUBCONTRACTOR SHALL RE-FLASH AND SEAL CURBS.
- PROVIDE CONDENSATE TRAP PER MANUFACTURER RECOMMENDATIONS, WITH HAND-TIGHT PLUGS,
- EXISTING TOILET ROOM EXHAUST FAN, AIR DEVICES, AND DUCTWORK TO
- REMOVE DUCTWORK, AIR DEVICES, AND TERMINAL AIR BOXES SHOWN IN DASHED LINES.
- 7 REMOVE ALL HOT WATER SUPPLY AND RETURN PIPING.
- PROVIDE 90 DEG. ELBOW WITH FLEX CONNECTOR AT FAN DISCHARGE AND EXTEND EXHAUST DUCT UP INTO CURB CAP PROVIDED WITH FAN PACKAGE. PROVIDE 2-1/2" FOIL FACED BATT INSULATION BETWEEN ROOF DECK AND FAN OUTLET. SEE FAN SCHEDULE.
- 9 CAP EXISTING DUCT BRANCH AFTER REMOVAL OF DUCTWORK. (TYPICAL)
- 10 EXISTING GAS PIPING ON ROOF TO REMAIN, SHOWN FOR REFERENCE ONLY.
- 11 MAKE GAS PIPING CONNECTION TO EQUIPMENT AND PROVIDE AGA RATED BALL VALVE AND DIRT LEG AT BASE OF DROP. VERIFY EXACT CONNECTION REQUIREMENTS AT JOB SITE.
- 12 PROVIDE PATE® "MULTIPLE PIPE CURB" AT ROOF PENETRATIONS, FOR REFRIGERANT AND CONDENSATE LINES AS WELL AS ELECTRICAL CONDUITS, COORDINATE WITH ELECTRICAL CONTRACTOR.
- 13 PROVIDE EQUIPMENT SUPPORT AS MANUFACTURED BY PATE® MODEL "ES-5", OR APPROVED EQUAL BY RPS CORPORATION.
- 14 FROM EACH CONDENSING UNIT, EXTEND SUCTION AND LIQUID REFRIGERATION LINES AS RECOMMENDED BY EQUIPMENT SUPPLIER. ALL PIPE SIZING SHALL BE BY EQUIPMENT SUPPLIER.
- 15 MANUAL STARTER WITH PILOT LIGHT. SEE FAN SCHEDULE.
- 16 PROVIDE NEW ELECTRIC WALL HEATER AND PATCH WALL AS REQUIRED. SEE EQUIPMENT DATA.
- 17 CONNECT CONDENSATE PIPING TO HEAT PUMP AND EXTEND UP THROUGH ROOF. VERIFY CONDENSATE PIPE SIZE AND TRAP REQUIREMENTS WITH EQUIPMENT SUPPLIER AT JOB SITE.
- 18 THIS PIPING LOCATED ABOVE CEILING AND/R UNDERSIDE OF STRUCTURE ABOVE.
- 19 EXHAUST FAN EF-4 SHALL RELIEVE HEAT FROM IT CLOSET INTO CEILING PLENUM IN RESPONSE TO REVERSE ACTING THERMOSTAT PROVIDE WITH FAN PACKAGE. TCC TO PROVIDE INTERLOCK WIRING BETWEEN FAN AND STAT.
- 20 CONNECT NEW 3/4" SCHEDULE 40 BLACK STEEL GAS LINE FOR AH-B TO 3" MAIN. VERIFY SIZE & PRESSURE AT MAIN. PROVIDE BALL VALVE SHUTOFF AT MAIN AND NEW REGULATOR AT UINIT. PRESSURE AT MAIN ASSUMED TO BE 2 PSIG. NATURAL GAS LOAD AT NEW AH UNIT IS 125 CFH.
- 21 TEMPERATURE CONTROLS CONTRACTOR SHALL INTEGRATE NEW ZONE DAMPERS AND RTU WITH EXISTING i-Vu BUILDING AUTOMATION SYSTEM. SEE ZONE DAMPER SCHEDULE.
- 22 HARDWIRED THERMOSTAT FOR HP-1.
- 23 HARDWIRED THERMOSTAT FOR HP-2.
- 24 HARDWIRED THERMOSTAT FOR HP-3.
- 25 HARDWIRED THERMOSTAT FOR HP-4.
- 26 PLUMBING CONTRACTOR TO CLEAN, PRIME AND PAINT ALL NEW FUEL GAS PIPING WITH WITH 2 COATS OF BLACK EXTERIOR GRADE ENAMEL.
- 27 AH-A BYPASS DAMPER. SEE ZONE DAMPER SCHEDULE.
- 28 PROVIDE NEW FLEX AND RECONNECT NEW AIR DEVICE TO EXISTING DUCTWORK AND BALANCE TO AIR FLOW SHOWN.
- 29 UNLESS OTHERWISE NOTED, REMOVE ALL EXISTING THERMOSTATS, WIRING AND/OR PNEUMATIC TUBING BACK TO SOURCE IN CONTRACT AREA.
- 30 REMOVE FAN COIL THERMOSTAT AND RETURN TO OWNER.

PIPING. RETURN CONDENSING UNITS TO OWNER.

- 31 REMOVE FAN COIL UNITS, POWER, INTERLOCK WIRING AND ALL PIPING AND RETURN TO OWNER
- 32 EXISTING HOT WATER CABINET HEATER AND THERMOSTAT TO BE REMOVED.
- 33 BYPASS DAMPER FOR AH-B. SEE ZONE DAMPER SCHEDULE AND AIR DEVICE SCHEDULE ITEM 16, SHEET H0-1.
- 34 REMOVE I.T. ROOM CONDENSING UNITS AND ALL POWER AND REFRIGERANT

- 35 NUMBER INDICATES AIR FLOW BALANCE QUANTITY IN CFM.
- 36 REMOVE EXISTING THERMOSTAT AND RETURN TO OWNER.
- 37 REMOVE ALL DUCTWORK AND AIR DEVICES IN THIS AREA.
- 38 PROVIDE SMALL PLATE TO MATCH COLOR OF WALL AT OPENING LEFT BY THERMOSTAT REMOVAL.
- 39 RUBBER PIPE SUPPORT WITH EMBEDDED UNISTRUT CHANNEL. DURA-BLOCK OR EQUAL.
- 40 ADJUST HOT WATER BALANCING VALVE TO 89 GPM.
- 41 ABOVE CEILING RETURN AIR TRANSFER DUCT. PROVIDE 2 12" X 12" ACOUSTICALLY LINED ELBOWS.
- 42 GRAVITY BACKDRAFT DAMPER. SEE AIR DEVICE SCHEDULE.
- 43 REMOVE ALL HIGH- AND LOW-PRESSURE DUCTWORK, AIR DEVICES, HOT WATER AND PNEUMATIC PIPING, VALVES, FITTINGS, COILS, CONTROLS, ETC. IN THIS
- 44 CONNECT NEW 1/2 " SCHEDULE 40 BLACK STEEL GAS LINE FOR AH-C TO 3" MAIN. VERIFY SIZE & PRESSURE AT MAIN. PROVIDE BALL VALVE SHUTOFF AT MAIN AND NEW REGULATOR AT UINIT. PRESSURE AT MAIN ASSUMED TO BE 2 PSIG. NATURAL GAS LOAD AT NEW AH UNIT IS 65 CFH
- 45 CONNECT NEW 1/2 " SCHEDULE 40 BLACK STEEL GAS LINE FOR AH-D TO 3" MAIN. VERIFY SIZE & PRESSURE AT MAIN. PROVIDE BALL VALVE SHUTOFF AT MAIN AND NEW REGULATOR AT UINIT. PRESSURE AT MAIN ASSUMED TO BE 2 PSIG. NATURAL GAS LOAD AT NEW AH UNIT IS 110 CFH.
- 46 CAP AND SEAL OPEN RETURN AIR DUCT ABOVE CEILING, AND ABANDON VERTICAL SECTION OF DUCT. RETURN DUCT SHOWN ON 1969 DRAWINGS IS 54" X 14".
- 47 REMOVE 22" DIA. SPIRAL DUCT AND PROVIDE INSULATED CAP AND SEAL.
- 48 24" SUPPLY DUCT RISER TO REMAIN.
- 49 REMOVE HOT WATER SUPPLY AND RETURN RISERS.
- 50 EXISTING RETURN AIR RISER TO REMAIN.
- PROVIDE SADDLE AND NEW 24" X 24" MOTOR OPERATED STATIC PRESSURE CONTROLLED BYPASS DAMPER TO TRANSFER 6,250 CFM FROM SUPPLY DUCT TO RETURN DUCT. YOUNG REGULATOR MODEL No. 3092 OR ENGINEER APPROVED EQUAL.
- 52 REMOVE FIRST FLOOR HOT WATER SUPPLY AND RETURN PIPING BACK TO THIS POINT AND CAP.
- PROVIDE 1-1/2" BALANCING VALVE BETWEEN 2-1/2" SUPPLY AND RETURN PIPING. BALANCE TO BYPASS 31 GPM FROM SUPPLY TO RETURN.
- 54 ADJUST TERMINAL BOX BALANCING VALVE TO 3 GPM.
- 55 ALL EXISTING DUCTWORK, TERMINAL BOXES, AND COILS SHALL BE CLEANED. SEE SPECIFICATION ITEM AIR DUCT / SYSTEM CLEANING.

### EQUIPMENT DATA H

### HEAT PUMPS (4 REQUIRED)

RK		HP-1 thru HP-4
	TYPE	. CEILING CASSETTE HEAT-PUMP
	COOLING CAPACITY	. 24 MBH
	HEATING CAPACITY	15.1 MBH @ 17F
	CFM (Lo-Med-Hi)	. 625 / 761 / 878
	ELECTRICAL	. SEE ELECTRICAL DRAWINGS
	ACCESSORIES	. WALL MOUNTED THERMOSTAT (4 REQD.)
		GRILLE / CEILING PANEL
		24V INTERFACE KIT
	MFR.& MODEL #	. CARRIER "40MBCQ24" (INDOOR UNIT)
		CARRIER "38MARBQ24AA3" (OUTDOOR UNIT
		OR APPROVED EQUAL BY MITSUBISHI WITH

LOW AMBIANT WIND BAFFLE

### WALL HEATER

MARK		WH-1
	TYPE	RECESSED
	CAPACITY	2 KW / 6.8 MBH
	CFM	100
	ELECTRICAL	SEE ELECTRICAL DRAWINGS
	ACCESSORIES	RECESSED MOUNTING FRAME, TRIM RING
		INTEGRAL DISCONNECT SWITCH AND
		TERMOSTAT
	MFR.& MODEL #	QMARK "AWH SERIES 4000", OR
		EQUAL BY BERKO

### HVAC GENERAL NOTES

- WHERE REFERENCE IS MADE TO AN EXISTING PIPE, DUCT, OR PIECE OF EQUIPMENT, CONTRACTOR SHALL FIELD VERIFY EXACT SIZE, MODEL NUMBER, SERIAL NUMBER, AND LOCATION PRIOR TO FABRICATION AND/OR ORDERING MATERIALS.
- THE EXISTING MECHANICAL EQUIPMENT, DUCTWORK, AND PIPING SHOWN ON THESE DRAWINGS ARE SHOWN IN THEIR APPROXIMATE LOCATION AND MUST BE FIELD VERIFIED.
- 3 CONTRACTOR SHALL COORDINATE THE LOCATION OF ALL PIPES, DUCTS, TERMINAL AIR UNITS, ETC. WITH THE OTHER TRADES AND SHIFT LOCATION OR OFF-SET WHERE NECESSARY. WORK BY OTHER TRADES ISN'T RESTRICTED TO NEW WORK BUT ALSO INCLUDES EXISTING ITEMS SUCH AS ELECTRICAL CONDUITS, STORM PIPING, ETC.
- 4 ALL PIPING SHALL BE INSTALLED IN A MANNER THAT WILL ACCOMMODATE THERMAL EXPANSION.
- UNLESS OTHERWISE INDICATED, ALL NEW SUPPLY DUCTWORK SHALL BE ACOUSTICALLY LINED SHEET METAL WITH 1-1/2" DUCT LINER (MIN. R=6). RETURN AIR DUCTWORK NEED NOT BE INSULATED. IN LIEU OF DUCT LINER ON ROUND SUPPLY DUCT, CONTRACTOR MAY USE 2.2" FOIL FACED BATT INSULATION (MIN.
- ALL EQUIPMENT, PIPING, DUCTWORK, CONTROLS, VALVES, ETC, NOTED TO BE REMOVED SHOULD ALSO BE DISPOSED OF UNDER THIS SECTION OF THE WORK UNLESS THE OWNER WISHES TO RETAIN POSSESSION OF SPECIFIC ITEMS.
- 7 CONTRACTOR SHALL BE RESPONSIBLE FOR TESTING OF ALL EXISTING GAS, AND WATER SYSTEMS WHEN NEW EQUIPMENT ARE INSTALLED ON EXISTING SYSTEMS. TESTING SHALL BE PER CODE AND LOCAL INSPECTION AGENCY REQUIREMENTS.
- TEMPERATURE CONTROLS CONTRACTOR (TCC) SHALL PROVIDE ALL LOW AND HIGH VOLTAGE WIRING TO CONTROL PANELS, RTUs, ZONE DAMPERS, SPLIT SYSTEMS, THERMOSTATS, ETC. SEE ELECTRICAL DRAWINGS FOR POWER WIRING. ALSO SEE ZONE DAMPER AND AIR HANDLING UNIT SCHEDULES FOR TCC SUBCONTRACTOR PRICING TO BE INCLUDED IN YOUR BID, CONTACT TIM SPENCER CARRIER COMMERCIAL SERVICES 937-604-3976.
- 9 ALL ROOF WORK INCLUDING FLASHING AND PATCHING SHALL BE COMPLETED BY THE OWNER'S ROOFING CONTRACTOR TO MAINTAIN WARRANTY. FOR SUBCONTRACTOR PRICING, CONTACT COTTERMAN ROOFING AT 800-713-3190.
- 10 BELOW DECK STRUCTURAL SUPPORTS AND FRAMING FOR ROOF MOUNTED MECHANICAL EQUIPMENT SHALL BE PROVIDED BY GENERAL CONTRACTOR (GC). ABOVE DECK HOLD DOWN CLIPS AND/OR WIND LOAD RESTRAINTS FOR MECHANICAL EQUIPMENT SHALL BE DESIGNED BY STRUCTURAL ENGINEER AND INSTALLED BY GC. REF: OMC SECTION 301.15.

### HVAC LEGEND

LOW PRESSURE DUCTWORK

FLEXIBLE DUCT RUNOUT/CONNECTOR

ZONE DAMPER

SUPPLY AIR DEVICE

RETURN OR EXHAUST AIR DEVICE

VANED ELL (MITER)

HOT WATER SUPPLY LINE

HOT WATER RETURN LINE

DDC TEMPERATURE SENSOR WITH EXTERNAL ADJUSTMENT & INTEGRAL TEMPERATURE READOUT

PNEUMATIC ROOM THERMOSTAT

DISCHARGE AIR

EXHAUST OR INTAKE AIR

ROOM NUMBER

NOTE SYMBOL

1 AIR DEVICE SYMBOL

BALANCE VALVE

RETURN AIR OPENING IN WALL ABOVE CEILING...
NUMBER INDICATES AREA (GROSS) IN SQUARE FEET.

### HVAC - SHEET INDEX

H0-1 HVAC - LEGEND, GENERAL NOTES, DRAWING NOTES, EQUIPMENT DATA,

1-1 HVAC - PARTIAL FIRST FLOOR PLANS - DEMOLITION & REVISED

H1-2 HVAC - PARTIAL ROOF PLAN - DEMOLITION & REVISED
H1-3 HVAC - PARTIAL GROUND FLOOR PLAN & HVAC SCHEDULES


H2-1 HVAC - DUCTWORK CLEANING - PARTIAL FLOOR PLANS

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of Moraine, OH 45439

Moraine, OH 45439

Print Record
07/29/22 FINAL CHECK SET

03/06/23 FINAL REVIEW

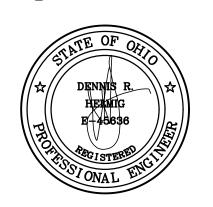Project Numbers

2020-149/6614


Date
JANUARY 28, 2022

Sheet Title

HVAC LEGEND, GENERAL NOTES, DRAWING NOTES, EQUIPMENT DATA

Sheet Number

H0 - 1

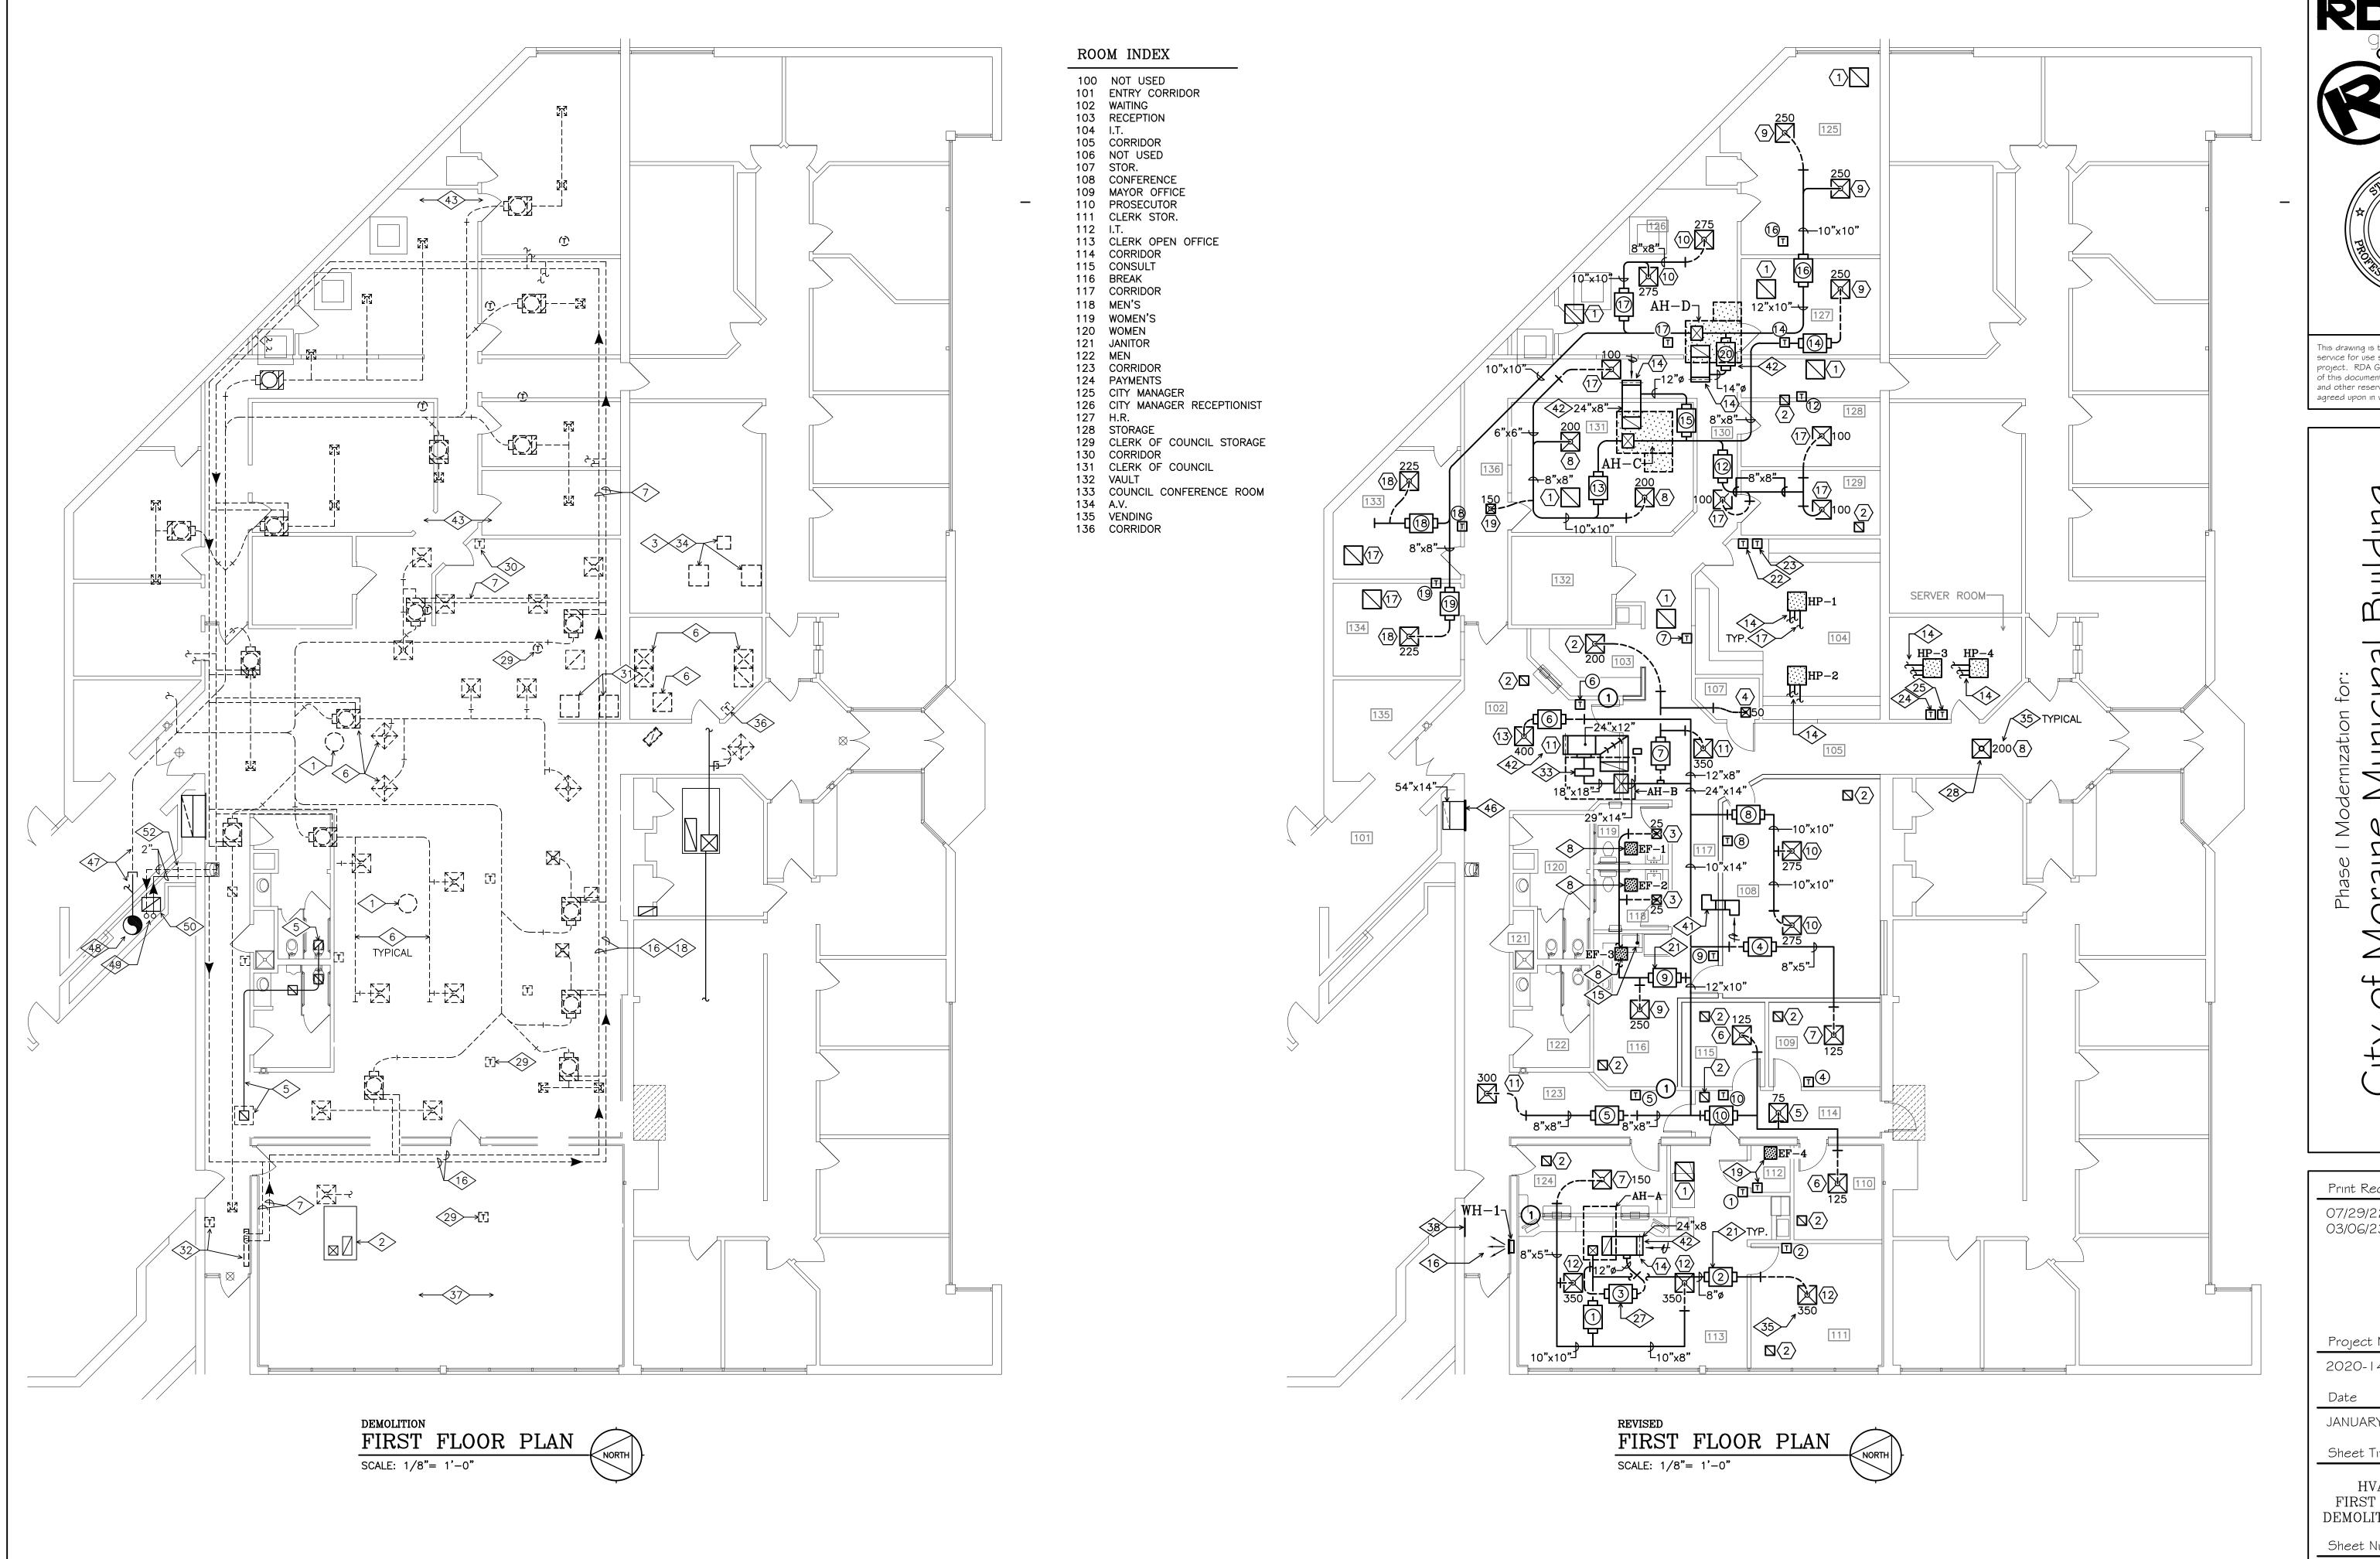

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Project Numbers

2020-149/6614

JANUARY 28, 2022

Sheet Title

HVAC PARTIAL FIRST FLOOR PLANS DEMOLITION & REVISED

Sheet Number

Helmig Lienesch LLC Consulting Engineers

410 South Jefferson Street Dayton, Ohio 45402

(937) 228-4007 FAX: (937) 228-1936

H1 - 1





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Project Numbers

2020-149/6614

Date

JANUARY 28, 2022

Sheet Title

HVAC PARTIAL ROOF PLAN DEMOLITION & REVISED

Sheet Number

(937) 228-4007 FAX: (937) 228-1936

410 South Jefferson Street Dayton, Ohio 45402

H1-2

					AIR DI	EVICE SCH	EDULE				
ТҮРЕ						FINISH		MISCELLANEOUS			
1CEILING DIFFUSER 2LOUVERED SUPPLY GRILLE 3SQUARE PLAQUE DIFFUSER 4ADJUSTABLE SLOT - "FLOWBAR" 5ALUM. BAR GRILLE - TRANSFER 6EXTERIOR WALL LOUVER 7LINEAR SLOT DIFFUSER 8INSUL. PLENUM SLOT DIFFUSER			9BACKDRAFT DAMPER 10LINEAR BAR GRILLE-SUPPLY 11LINEAR BAR GRILLE-RETURN 12DOUBLE DEFL. SUPPLY REG. 13ALUMINUM EGG CRATE 14INTAKE LOUVER 15ADJUSTABLE SLOT DIFFUSER 16ALUMINUM CONTROL DAMPER			21WHITE ENAMEL 22STANDARD 23ETCHED & LACQUERED 24SEE ARCH. FOR FINISH 25ENAMEL-STD COLOR 26304 STAINLESS STEEL		314-WAY 32BIRD S 33EXTER 34ALIGNI 35BLACK 36INSUL.	ME DAMPER PATTERN ADJ. CREEN (ALUMINUM) INSUL. PLENUM MENT STRIPS INTERNALS PLENUM BY S/M OUNTERWEIGHT @ 0.	412-POS. CON	RAMÈ IN CONTROLLERS
MARK	DEVICE SIZE	NECK SIZE	DUTY	CFM	ТҮРЕ	MFR.	MODEL No.	FINISH	MISC.	CLG./MTG.HT.	NOTES
1	24" X 24"	22" X 22"	RETURN	VARIES	13	PRICE	80D	21	30	CEILING	
2	12" x 12"	10" X 10"	RETURN	VARIES	13	PRICE	80D	21	30	CEILING	
3	12" X 12"	4"Ø	SUPPLY	25	3	PRICE	SPD	21	30	CEILING	
4	12" X 12"	4"Ø	SUPPLY	50	3	PRICE	SPD	21	30	CEILING	
5	24" x 24"	6"Ø	SUPPLY	75	3	PRICE	SPD	21	30	CEILING	
6	24" x 24"	6"Ø	SUPPLY	125	3	PRICE	SPD	21	30	CEILING	
7	24" x 24"	6"Ø	SUPPLY	150	3	PRICE	SPD	21	30	CEILING	
8	24" x 24"	6"Ø	SUPPLY	200	3	PRICE	SPD	21	30	CEILING	
9	24" x 24"	8"Ø	SUPPLY	250	3	PRICE	SPD	21	30	CEILING	
10	24" x 24"	8"Ø	SUPPLY	275	3	PRICE	SPD	21	30	CEILING	
11	24" x 24"	8"Ø	SUPPLY	300	3	PRICE	SPD	21	30	CEILING	
12	24" x 24"	8"Ø	SUPPLY	350	3	PRICE	SPD	21	30	CEILING	
13	24" x 24"	10"Ø	SUPPLY	400	3	PRICE	SPD	21	30	CEILING	
14	24" X 8"	24" X 8"	BACKDRAFT	VARIES	9	GREENHECK	BR-30	22	37	PLENUM	
15	24" x 12"	24" x 12"	BACKDRAFT	VARIES	9	GREENHECK	BR-30	22	37	PLENUM	
16	18" x 18"	18" x 18"	BYPASS	2,250	16	GREENHECK	VCD	22	38	PLENUM	
	24" x 24"	6"Ø	SUPPLY	100	3	PRICE	SPD	21	30	CEILING	
17		8"Ø	SUPPLY	225	3	PRICE	SPD	21	30	CEILING	
17 18 19	24" x 24" 12" X 12"	5"Ø	SUPPLY	150	3	PRICE	SPD	21	30		

							FAN	SCHEDUL	LE						
FAN TYP	PΕ						_	ELECTRICAL DAT	ГА	_		MISCELLANEOUS			
2AIRF 3BACk 4FOR\ 5IN-LIN 6PROI	WARD INCLINED  13PROPELLER-PANEL MOUNT UNIT  VARD CURVED  14UP-BLAST ROOF  E  15HOODED ROOF UNIT		DUNT UNIT	20REFER TO ELECTRICAL DRAWINGS 21INTEGRAL SAFETY SWITCH 222-SPEED MOTOR & SWITCH 23VARI-GREEN SPEED CONTROLLER 24MANUAL STARTER W/PILOT LIGHT 25MOTION SENSOR W/15 MIN. TIME DELAY 26VARIABLE FREQUENCY DRIVE				30ROOF CAP W/BIRDSCREEN & CURB 31BIRD SCREEN (ALUMINUM) 32SPRING ISOLATOR HANGER KIT 33REVERSE ACTING THERMOSTAT 34HIGH EFFICIENCY MOTOR 35							
MARK	CFM	SERVES	SP IN. WG	FAN RPM	WATTS	FAN TYPE	MFR.	MODEL No.	DUTY	BUILDING OPENING	DRIVE	WHEEL DIA.	ELEC. DATA	MISC.	NOTES
EF-1	75	ROOM 119	0.375	850	13.4	7	GREENHECK	SP-A90-VG	EXHAUST	8" Ø	DIRECT		20,21,23	30,32	1
EF-2	75	ROOM 118	0.375	850	13.4	7	GREENHECK	SP-A90-VG	EXHAUST	8" Ø	DIRECT		20,21,23	30,32	1
EF-3	125	ROOM 166	0.375	940	22.4	7	GREENHECK	SP-A130-VG	EXHAUST	8" Ø	DIRECT		20,21,23,24	30,32	1
EF-4	100	ROOM 112	0.375	1020	17	7	GREENHECK	SP-A110-VG	EXHAUST		DIRECT		20,21,23	32,33	1


NOTE: 1) MAXIMUM INLET SOUND LEVEL SHALL BE 2.5 SONES (AMCA 311 AT 5.0 FT)

MARK	CFM	INLET COLLAR SIZE	MAX. PRESSURE DROP	CARRIER MODEL NUMBER	AH#	THERMOSTAT LOCATION ROOM No.	NOTES
1	850	14" Ø	0.08" WG	OPNDR14	AH-A	113	1
2	350	8" Ø	0.08" WG	OPNDR8	AH-A	111	1
3	900	12" Ø	0.12" WG	OPNDR12	AH-A BYPASS		2
4	150	6" Ø	0.08" WG	OPNDR06	AH-B	109	1
5	300	8" Ø	0.08" WG	OPNDR08	AH-B	123	1
6	400	8" Ø	0.08" WG	OPNDR08	AH-B	102	1
7	600	10" Ø	0.08" WG	OPNDR10	AH-B	103	1
8	550	10" Ø	0.08" WG	OPNDR10	AH-B	108	1
9	300	8" Ø	0.08" WG	OPNDR08	AH-B	116	1
10	325	8" Ø	0.08" WG	OPNDR08	AH-B	114	1
11	2,250	18" X 18"	0.12" WG		AH-B BYPASS		2,3
12	300	8" Ø	0.08" WG	OPNDR08	AH-C	128	1
13	650	12" Ø	0.08" WG	OPNDR12	AH-C	131	1
14	250	8" Ø	0.08" WG	OPNDR08	AH-C	127	1
15	900	12" Ø	0.12" WG	OPNDR12	AH-C BYPASS		2,3
16	600	10" Ø	0.08" WG	OPNDR10	AH-D	125	1
17	550	10" Ø	0.08" WG	OPNDR10	AH-D	126	1
18	300	8" Ø	0.08" WG	OPNDR08	AH-D	133	1
19	325	8" Ø	0.08" WG	OPNDR08	AH-D	134	1
20	1,200	14" Ø	0.12" WG	OPNDR14	AH-D BYPASS		2,3

NOTES: 1.) PROVIDE CARRIER "VVT ZONE II CONTROLLER - # OPN-VVTC-02" & "ZS PRO - #ZS2P-CAR SENSOR".

2.) PROVIDE CARRIER "VVT BYPASS II CONTROLLER - # OPN-VVTBP-02".

3.) SEE AIR DEVICE SCHEDULE, AIR DEVICE 16.

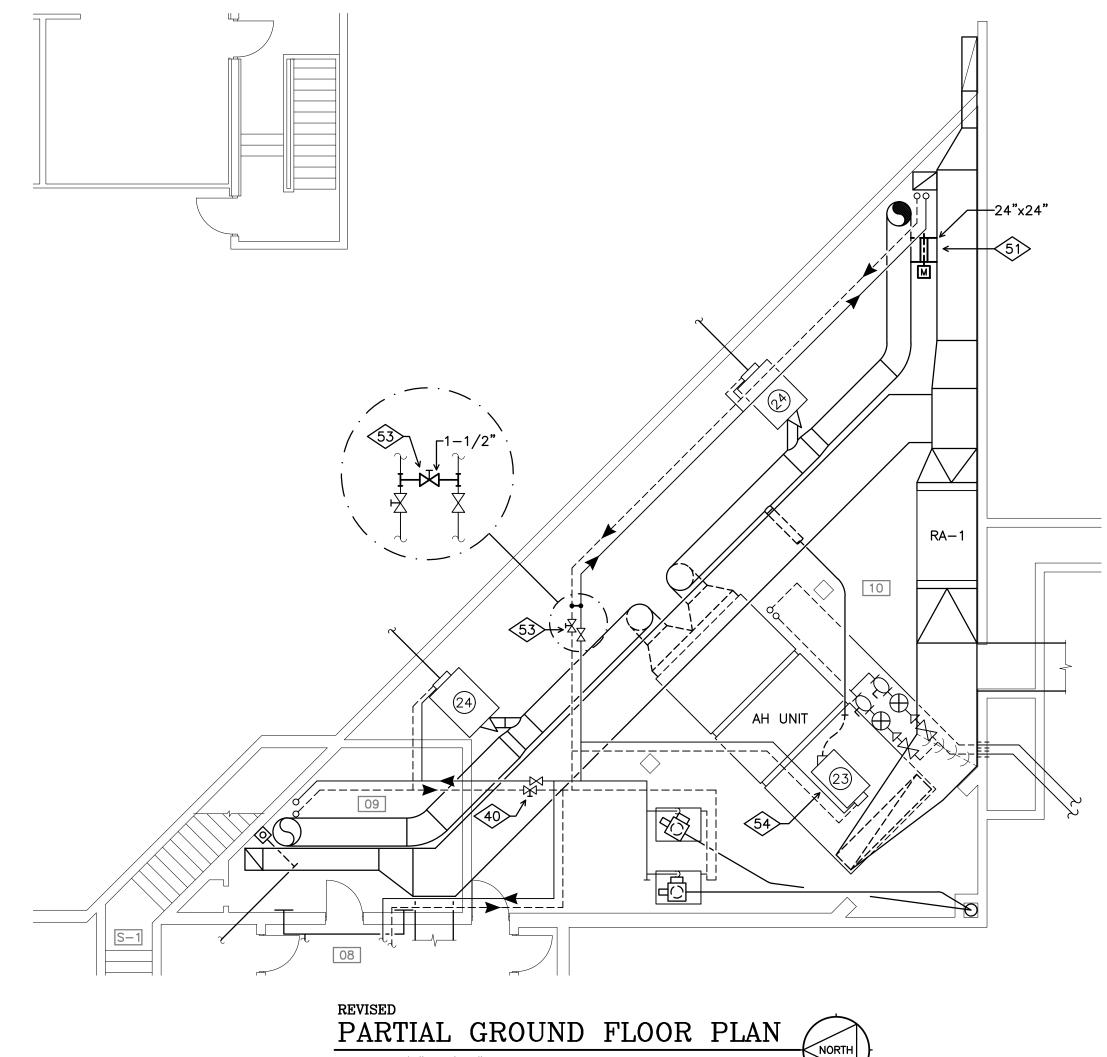

SCALE: 1/8"= 1'-0"

			OUTS	SIDE AIF	R - VEN	ΓΙLΑΤΙ	ON SUMI	MARY			
			FLOOR	OCCUPANT	OA	OA	OA		EXHAUST	VENTILATION	
SYSTEM	ROOM #	ROOM	AREA	DENSITY	CFM PER	RATE	REQUIRED	AIR	AIR	RATE	NOTES
		NAME	IN SF.	$(P_z)$	PERSON	CFM/SF	CFM	CLASS	REQUIRED	DESIGN	
			$(A_z)$	Actual	(Rp)	(Ra)	(Vbz)		CFM	CFM	
АН-В	102	WAITING	288	4	5	0.06	37	1		40	
AH-B	103	RECEPTION	180	2	5	0.06	21	1		25	
AH-B	104	IT	400	3	5	0.06	39	1		50	
AH-B	105	CORRIDOR	252	0	0	0.06	1	1		0	
AH-B	107	STORAGE	28	0	0	0.06	1	1		0	
АН-В	108	CONFERENCE	408	12	5	0.06	85	1		100	
AH-B	109	MAYOR OFFICE	108	1	5	0.06	16	1		20	
AH-B	110	PROSECUTOR	90	2	5	0.06	15	1		20	
AH-A	111	CLERK STORAGE	196	1	5	0.06	17	1		25	
АН-В	112	IT CLOSET	20	0	0	0.06	1	1		0	
AH-B	113	CLERK OPEN OFFICE	408	4	5	0.06	45	1		50	
AH-B	114	CORRIDOR	100	0	0	0.06	1	1		0	
AH-B	115	CONSULT	81	2	5	0.06	15	1		20	
AH-B	116	BREAKROOM	136	4	5	0.12	36	1		40	
AH-B	117	CORRIDOR	100	0	0	0.06	1	1		0	
AH-B	118	MEN'S TOILET	48	1		0.06	75	2	75	75	
AH-B	119	WOMEN'S TOILET	48	1		0.06	75	2	75	75	
AH-B	123	CORRIDOR	168	0	0	0.06	1	1		0	
AH-B	124	PAYMENTS	112	3	5	0.06	25	1		50	
		SERVER ROOM	168	0	0	0.06	1	1		0	
	TOTA	LS FOR AH-A & AH-B	3339				508			590	
АН-С	127	OFFICE	140	1	5	0.06	13	1		25	
АН-С	128	STORAGE	112	0	0	0.06	7	1		15	
АН-С	129	STORAGE	112	0	0	0.06	7	1		15	
АН-С	130	CORRIDOR	190	0	0	0.06	11	1		15	
АН-С	131	OFFICE	280	2	5	0.06	27	1		40	
АН-С	136	CORRIDOR	174	0	0	0.06	10	1		15	
	TC	OTALS FOR AH-C	1008				75			125	
AH-D	125	OFFICE	280	2	5	0.06	27	1		40	
AH-D	126	OFFICE	220	2	5	0.06	23	1		35	
AH-D	133	OFFICE	168	1	5	0.06	15	1		25	
AH-D	134	AV	140	1	5	0.06	13	1		25	
	TC	OTALS FOR AH-D	808				78			125	

NOTES: A) OUTDOOR AIR ANALYSIS BASED ON ASHRAE STANDARD 62.1 - 2016

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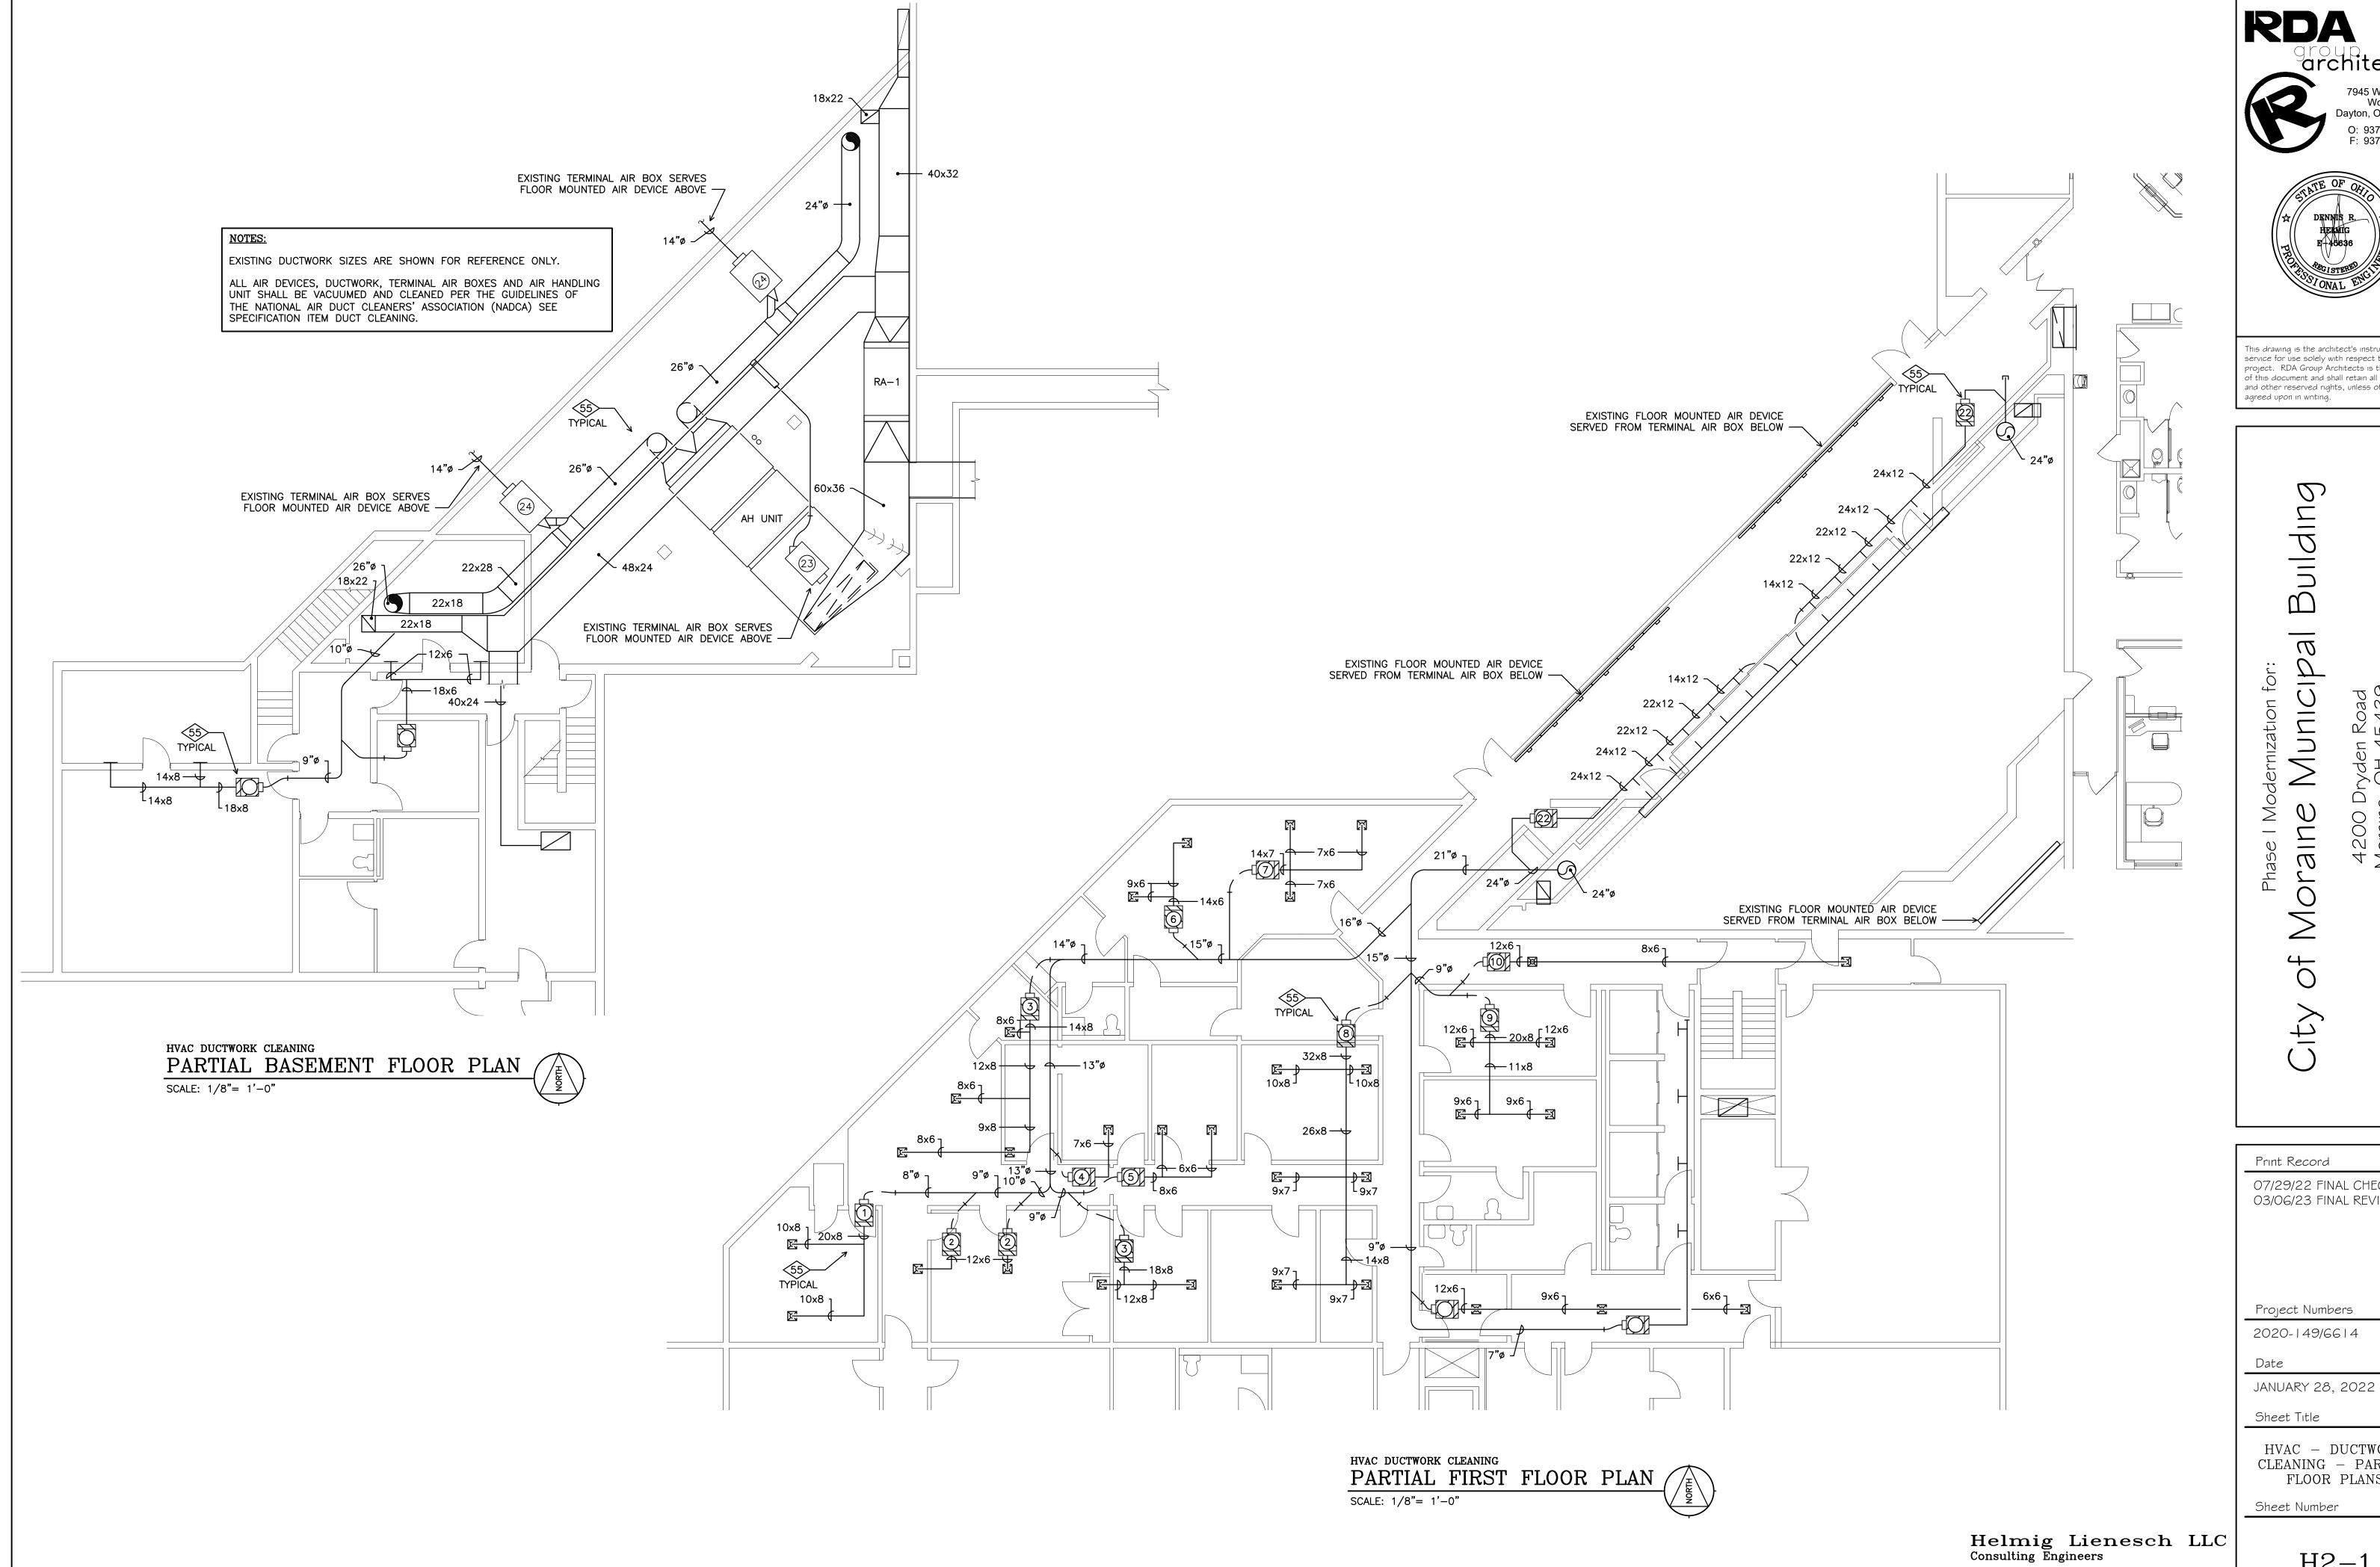
2020-149/6614

Date JANUARY 28, 2022

Sheet Title

HVAC PARTIAL GROUND FLOOR PLAN & HVAC SCHEDULES Sheet Number

H1-3



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Project Numbers

2020-149/6614

Date

Sheet Title

HVAC – DUCTWORK CLEANING – PARTIAL FLOOR PLANS

Sheet Number

(937) 228-4007 FAX: (937) 228-1936

410 South Jefferson Street Dayton, Ohio 45402

H2-1

20A-1P


NEMA L5-30R-

LNEMA L5-30R I.T. ROOM FLOOR PLAN  $\sqrt{E^{1-1}}$  SCALE: 1/4"= 1'-0"

I.T. ROOM

E1-1 HEIGHTS

└30A-1P

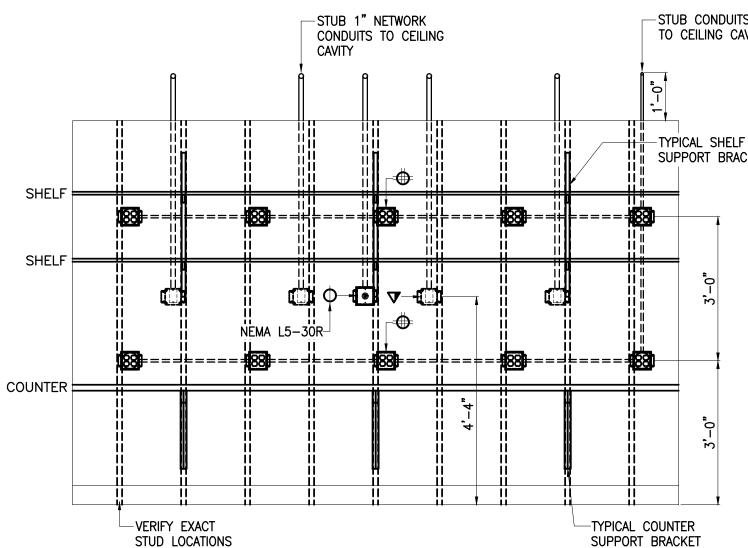

I.T. ROOM WALL DETAIL



CONDUIT CONCEALED ABOVE CEILING OR IN WALL WHENEVER POSSIBLE

---- CONDUIT CONCEALED IN OR BELOW FLOOR

INDICATES NUMBER OF CONDUCTORS IN CONDUIT TO BE USED AS A GENERAL GUIDE TO SHOW INTENT OF CIRCUITING AND SWITCHING ARRANGEMENT...NOT SHOWN IN ALL CASES...CONTRACTOR SHALL VERIFY AND INSTALL ADDITIONAL CONDUCTORS WHERE REQUIRED.

HOME-RUN TO PANELBOARD SHOWING CIRCUIT DESIGNATION, INDICATING PANEL AND CIRCUIT BREAKER NUMBER WITHIN THE PANEL...BREAKER LOCATIONS MAY BE REARRANGED TO PERMIT THE USE OF A COMMON NEUTRAL CONDUCTOR.

EACH ARROW INDICATES ONE COMPLETE CIRCUIT

ELECTRIC MOTOR CONNECTION

ELECTRICAL CONNECTION REQUIRED

CONDUIT RISE

CONDUIT DROP

MOUNTING HEIGHT DESIGNATION IN INCHES ABOVE FINISHED FLOOR TO CENTERLINE...WHEN INDICATED ON DRAWINGS SUPERSEDES STANDARD MOUNTING HEIGHT IN LEGEND

REFERENCE TO DETAIL √A-1

 $\langle 1 \rangle$ NOTE SYMBOL

HEAVY-DUTY, NEMA-1, NON-FUSIBLE DISCONNECT SWITCH

HEAVY-DUTY, NEMA-3R, FUSIBLE DISCONNECT SWITCH, WITH FUSE SIZE NOTED

DISCONNECT SWITCH PROVIDED INTEGRAL WITH EQUIPMENT

MANUAL STARTER WITH PILOT LIGHT @48"A.F.F.

JUNCTION BOX

EXISTING ELECTRIC PANELBOARD

FIXTURE CONNECTED TO EMERGENCY (GENERATOR POWERED) BRANCH CIRCUIT

SINGLE—FACED EXIT SIGN DOUBLE—FACED EXIT SIGN

EXISTING TO BE REMOVED (DEMOLITION)

EXISTING TO REMAIN

EXISTING RELOCATED

20A/125V/1PH/3W, 5-20R, RECEPTACLE @18"A.F.F.

20A/125V/1PH/3W, NEMA 5-20R, DUPLEX GFCI RECEPTACLE @18"A.F.F.

DOUBLE DUPLEX "QUAD" CONVENIENCE RECEPTACLES @18"A.F.F.

DOUBLE DUPLEX GFCI "QUAD" CONVENIENCE RECEPTACLES @18"A.F.F.

20A/125V/1PH/3W, NEMA 5-20R, DUPLEX GFCI RECEPTACLE FOR WATER COOLER. ELECTRICAL CONTRACTOR SHALL VERIFY EXACT MOUNTING LOCATION WITH WATER COOLER MANUFACTURERS DRAWINGS.

20A/125V/1PH/3W, NEMA 5-20R, DUPLEX GFCI RECEPTACLE W/WEATHERPROOF "IN-USE" COVERPLATE

NEMA L5-30R 120V-30A LOCKING RECEPTACLE AT @18"A.F.F. (OR AS NOTED)

NETWORK FLUSH WALL OUTLET, CONSISTING OF TWO-GANG BOX WITH ONE-GANG PLASTER RING, @18" A.F.F...STUB 1" CONDUIT WITH PULL WIRE TO ABOVE SUSPENDED CEILING. COVER PLATE AND WIRING BY

CARD READER @48"A.F.F. TO TOP

ALL ACCESS CONTROL WORK TO PROVIDED BY OWNER'S ACCESS CONTROL CONTRACTOR

FLAT TV POWER AND CABLE OUTLET - VERIFY HEIGHT WITH TV BEING INSTALLED LEGRAND HT2102WHV1 IN WALL TV KIT (OR EQUAL)

LEVITION FLUSH FLOOR BOX INCLUDING:

FBC2F-N NICKEL PLATED COVER PLATE FBBOX-GY FLOOR BOX

FBDIV LOW VOLTAGE DIVIDER FBLEV-GY LEVELING RING

T5833-W 20-AMP TYPE-C USB CHARGER/TAMPER RESISTANT RECEPTACLE, WHITE

FB2DE-I 2-Port DECORA RECESSED DATA STRAP 41643-W LEVITON QUICKPORT DECORA INSERT, 3-PORT WITH:

TWO 61110-OL6 EXTREME 6+ QUICKPORT CONNECTOR, CAT 6, BLUE AND ONE 41084-BW BLANK QUICKPORT INSERT, 10-PACK, WHITE

### **ABBREVIATIONS**

019 € <

017

O18

GALVANIZED RIGID CONDUIT ABOVE FINISHED FLOOR BKR BREAKER GROUND FAULT CIRCUIT PROTECTOR HORSEPOWER CONDUIT CIRCUIT JUNCTION BOX **EXISTING** KILOVOLT AMPERES ELECTRICAL CONTRACTOR KILOWATT **EMERGENCY** MAIN LUGS ONLY ELECTRICAL METALLIC CONDUIT NATIONAL ELECTRIC CODE EXISTING RELOCATED NON-FUSED FLUSH TEMPERATURE CONTROL FU FUSE TYPICAL GROUND WATER COOLER

### **ELECTRICAL - SHEET INDEX**

ELECTRICAL - PARTIAL FIRST FLOOR DEMOLITION PLAN

ELECTRICAL - PARTAIL FIRST FLOOR LIGHTING PLAN ELECTRICAL - PARTIAL FIRST FLOOR SYSTEMS PLAN

ELECTRICAL - PANELBOARD SCHEDULES

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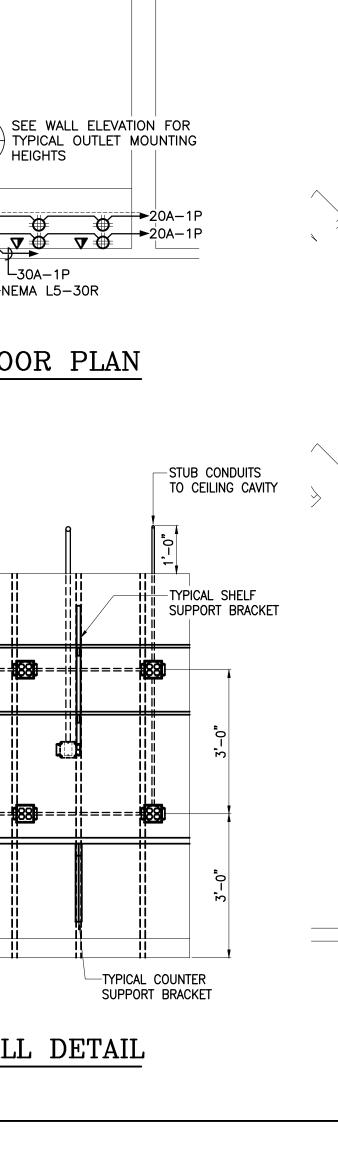
MARCH 20, 2023

Sheet Title

ELECTRICAL PARTIAL FIRST FLOOR DEMOLITION PLAN

Sheet Number

E1-1



O22

 $\bigcirc$ 32

O33

O34

**O**35

<u>⊗</u>i1

74 <sup>C</sup>

FLOOR PLAN SCALE: 1/8"= 1'-0"

38 °

40 <sup>©</sup>

-----2G[>

44

66 <sup>C</sup> 67 <sup>C</sup>

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52

54 <sup>O</sup>

GEN-D

55 ° 56 °


57 <sup>C</sup> 58 <sup>C</sup>

68 <sup>C</sup> 69 '

72 <sup>©</sup> 73 <sup>©</sup>


3/24/2023 % copyright 2023 © Helm


E1-1 SCALE: 1/2"= 1'-0"

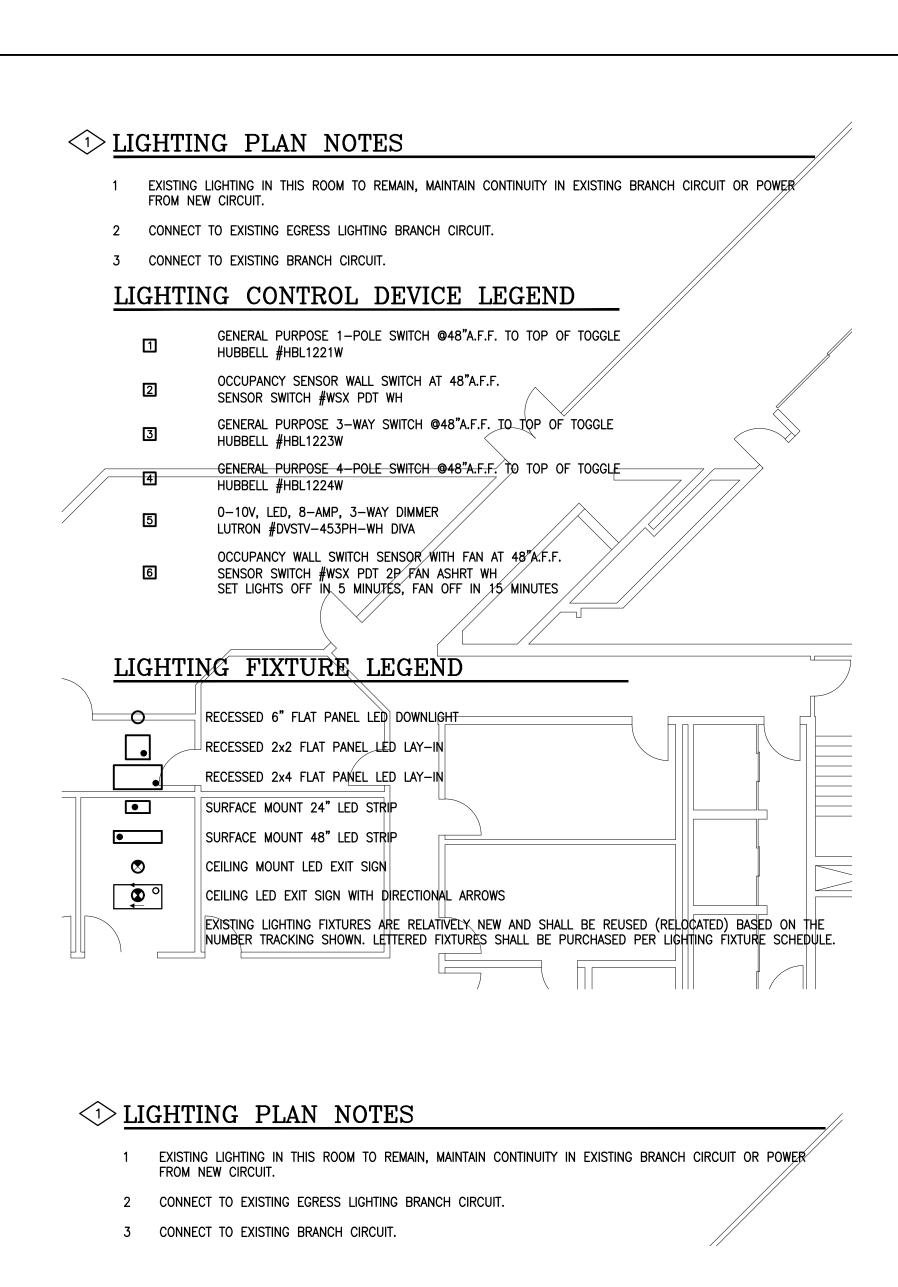

### LIGHTING FIXTURE SCHEDULE

Α	Type: 2x2 LED SELECTABLE BACKLIT PANEL Catalog: RAB #EZPAN2X2-40N/D10 Color: WHITE Lamping: 4,542 LUMENS 4000K (40 WATTS MAX.) Mounting Height: MOUNT IN CEILING GRID	
В	Type: 1x2 LED WRAPAROUND Catalog: RAB #GUS 18W (2FT) Color: WHITE Lamping: 2,140 LUMENS 4,000K (19 WATTS) Mounting Height: SURFACE MOUNTED	
EX	Type: LED EXIT SIGN WITH BATTERY BACKUP Catalog: COMPASS #CCRG Color: WHITE Lamping: (3.9 WATTS) Mounting Height: 90"A.F.F. TO CENTERLINE OR CEILING MOUNTING	EXIT

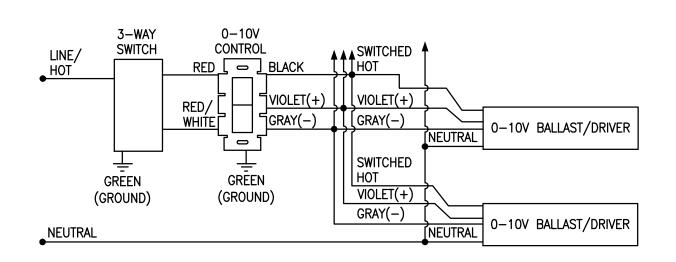

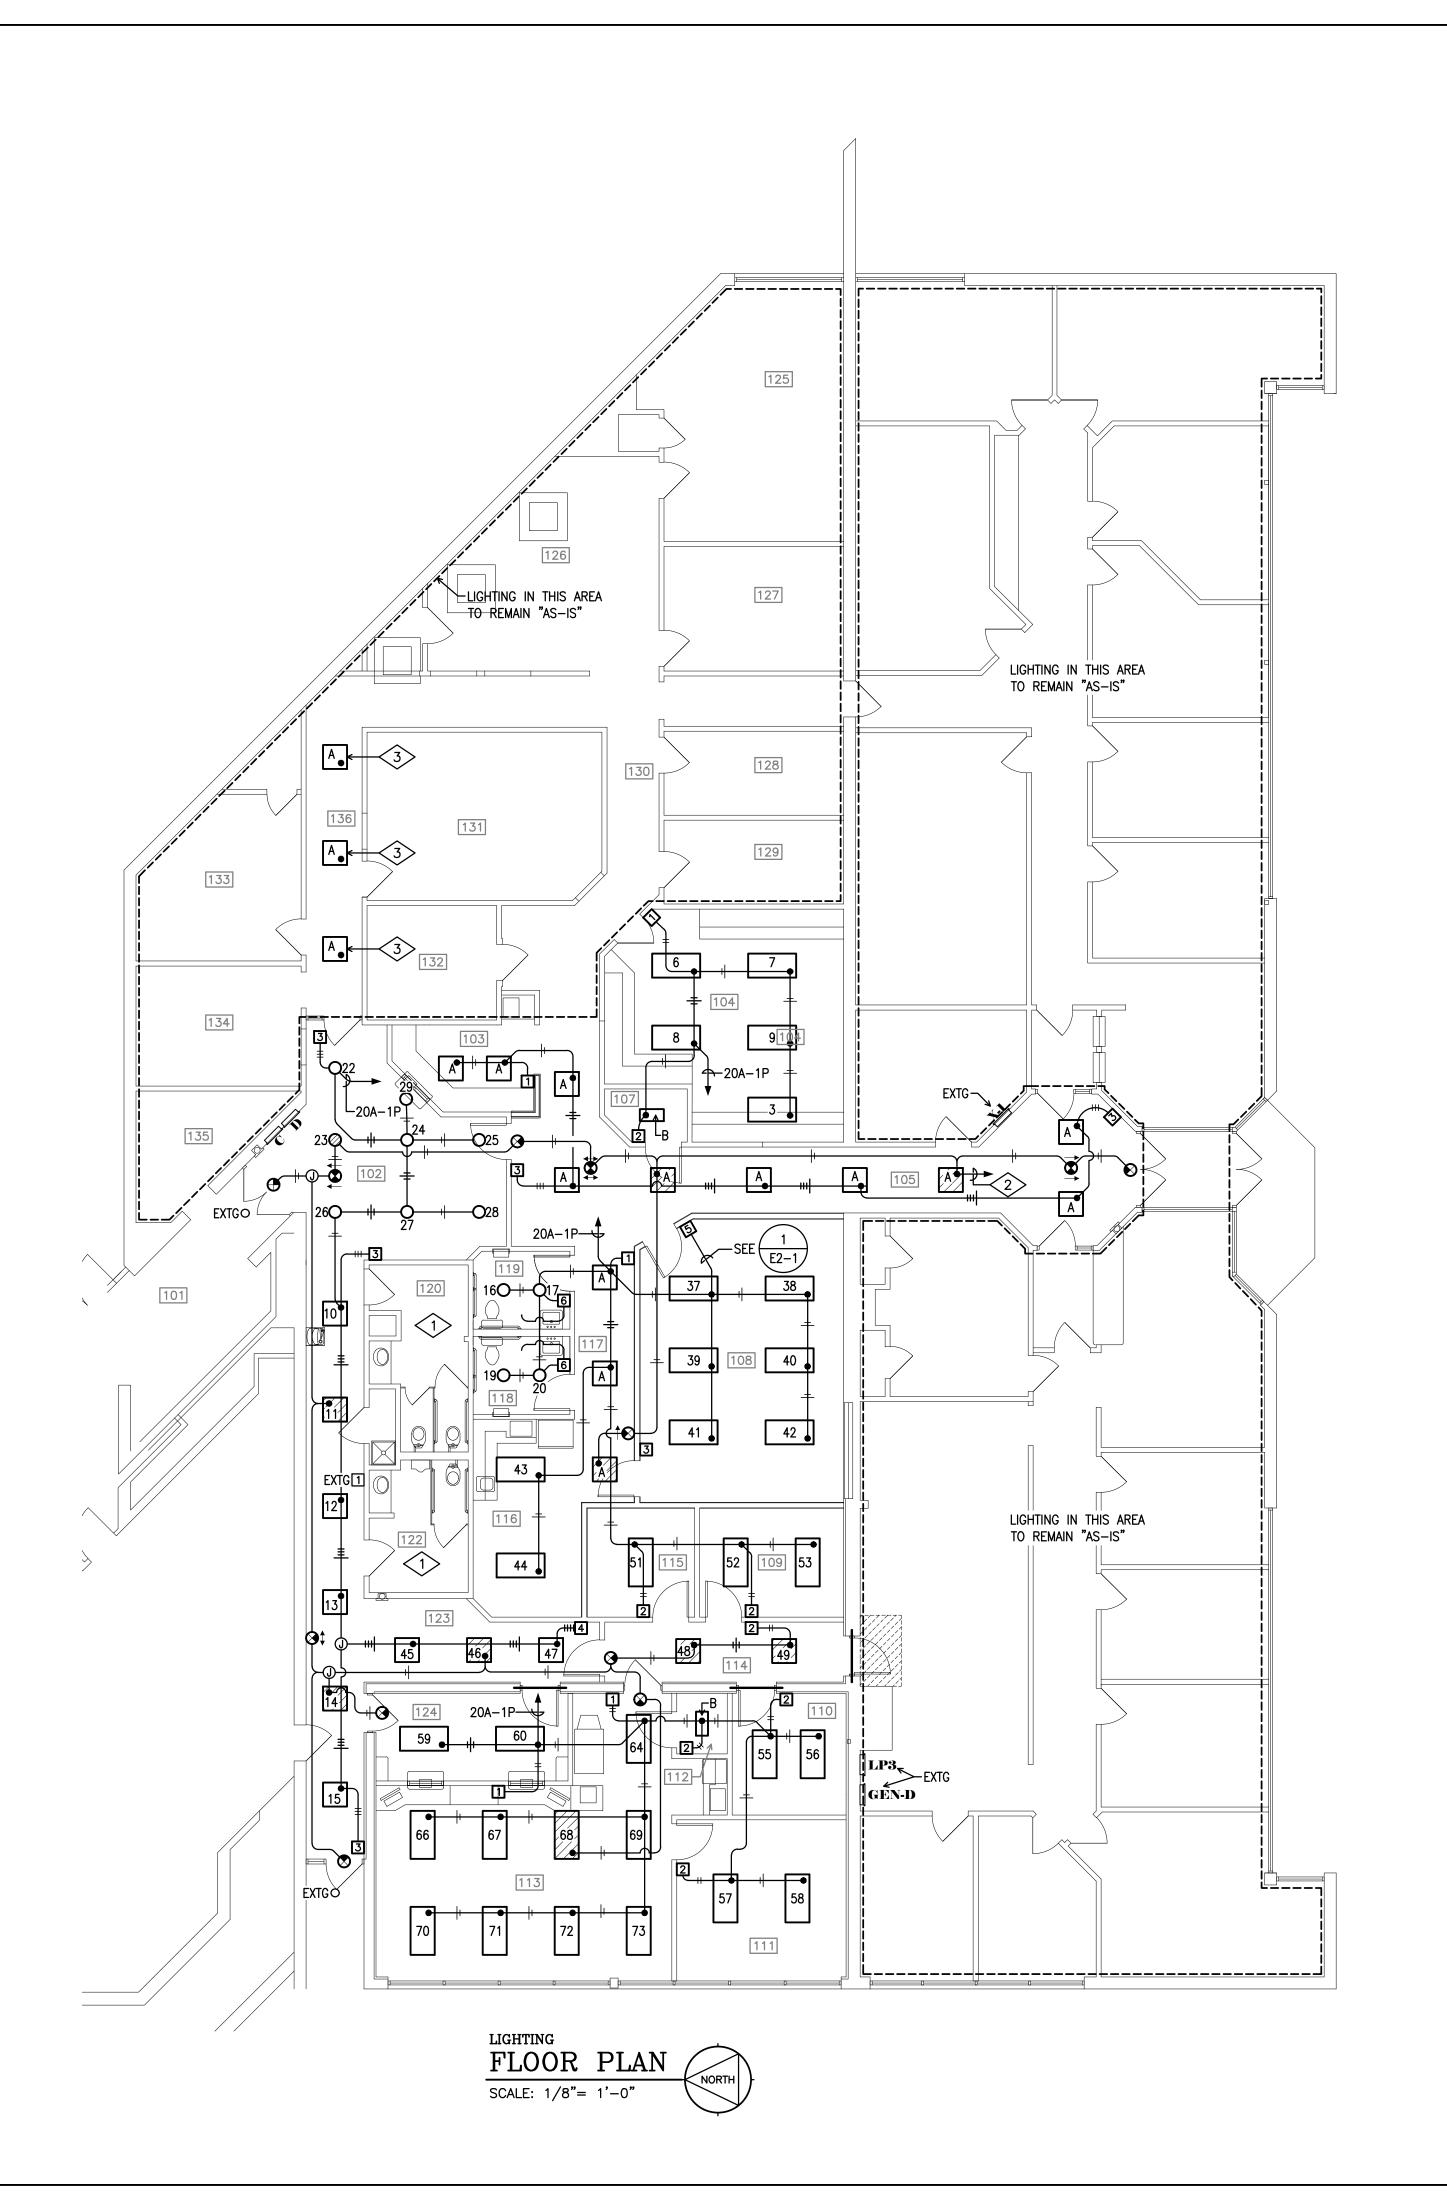





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### ROOM INDEX

100 NOT USED 101 ENTRY CORRIDOR

102 WAITING 103 RECEPTION

104 I.T. 105 CORRIDOR

106 NOT USED 107 STOR.

108 CONFERENCE 109 MAYOR OFFICE 110 PROSECUTOR

111 CLERK STOR. 112 I.T.

113 CLERK OPEN OFFICE 114 CORRIDOR 115 CONSULT

116 BREAK 117 CORRIDOR 118 MEN'S

119 WOMEN'S 120 WOMEN 121 JANITOR 122 MEN 123 CORRIDOR

124 PAYMENTS
125 CITY MANAGER
126 CITY MANAGER RECEPTIONIST 127 H.R.

128 STORAGE 129 CLERK OF COUNCIL STORAGE

130 CORRIDOR 131 CLERK OF COUNCIL 132 VAULT

133 COUNCIL CONFERENCE ROOM 134 A.V. 135 VENDING

136 CORRIDOR

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2020-149/6614

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Sheet Title

ELECTRICAL PARTAIL FIRST FLOOR

LIGHTING PLAN

Sheet Number

Helmig Lienesch LLC Consulting Engineers

410 South Jefferson Street (937) 228-4007 Dayton, Ohio 45402 FAX: (937) 228-1936 E2-1

### ♦ SYSTEMS PLAN NOTES


- 1 RELOCATED CARD READER. CARD READER ACCESS FROM CORRIDOR 123 EGRESS IS ALWAYS AVAILABLE FROM CORRIDOR 114.
- NEW SECURE ACCESS THAT CAN BE OPENED BY STAFF IN CASE OF EMERGENCY. DOOR TO REMAIN LOCKED WITH CARD READER ACCESS FROM BOTH SIDES.
- 3 CARD READER ACCESS FROM WAITING 102 EGRESS IS ALWAYS AVAILABLE FROM CORRIDOR 103.
- 4 PROVIDE DUCT MOUNTED SMOKE DETECTOR AND WIRE TO EXISTING FIRE ALARM PANEL IN SECURITY OFFICE.
- 5 PROVIDE UNISTRUT SUPPORT, ANCHORED TO CONDENSING UNIT SUPPORT RAILS, (COORDINATE WITH HVAC CONT'R.) TO MOUNT FUSIBLE DISCONNECT SWITCH.
- 6 TYPICAL..PROVIDE 14/3 CABLE WITH GROUND TO CONNECT INDOOR CASSETTE WITH CONDENSING UNIT.
- PROVIDE 3/4" x 48" x 96" PLYWOOD BACKBOARD PAINTED ON ALL SIDES WITH FIRE RETARDANT PAINT. MOUNT RECEPTACLES NEAR TOP CORNERS OF BACKBOARD. PROVIDE A 2" x 10" GROUNDING BAR AND #6 INSULATED CONDUCTOR BACK TO PANEL GROUND BUS SERVING RECEPTACLES.
- 8 ADD TWO 20A-1P AND TWO 30A-1P CIRCUIT BREAKERS TO EXISTING PANEL TO HANDLE NEW BRANCH CIRCUITS IN I.T. ROOM.
- 9 SECURITY CAMERA DROP BY OWNER'S SECURITY CONTRACTOR.
- 10 WP RECEPTACLE AND POWER TRANSFORMER PROVIDED WITH UNIT.
- 11 DEDICATED CIRCUIT FOR SHELF MOUNTED MICROWAVE RECEPTACLE. VERIFY HEIGHT WITH ARCHITECT ON JOB SITE.
- 12 TYPICAL LOCATE RECEPTACLES 6" ABOVE COUNTERTOP TO CENTERLINE.
- 13 PROVIDE RECEPTACLE BELOW COUNTER FOR UNDERCOUNTER REFRIGERATOR.
- 14 NEW CARD READER ACCESS EGRESS IS ALWAYS AVAILABLE FROM CORRIDOR 105.
- 15 EXISTING CARD READER ACCESS TO REMAIN.
- 16 CUT FLOOR SLAB AND INSTALL 3/4"C. FOR POWER AND 1" CONDUIT FOR DATA. RUN DATA CONDUIT TO CEILING CAVITY.
- 17 RUN NEW BRANCH CIRCUIT TO PANEL INDICATED AND PROVIDE 30A-3P "HACR" CIRCUIT BREAKER AND CONNECTION
- 18 PROVIDE WP RECEPTACLE ON UNITSTRUT APPX. 18" ABOVE ROOF.
- 19 PROVIDE 20A/120V BRANCH CIRCUIT AT THIS DOOR LOCATION FOR SECURITY ACCESS CONTROL CONTRACTOR'S

### ROOM INDEX

- 100 NOT USED
- 101 ENTRY CORRIDOR
- 102 WAITING 103 RECEPTION
- 104 I.T.
- 104 I.I. 105 CORRIDOR
- 106 NOT USED 107 STOR.
- 108 CONFERENCE
- 109 MAYOR OFFICE 110 PROSECUTOR
- 111 CLERK STOR.
- 112 I.T.
- 113 CLERK OPEN OFFICE 114 CORRIDOR
- 115 CONSULT
- 116 BREAK 117 CORRIDOR
- 118 MEN'S
- 119 WOMEN'S
- 120 WOMEN S
- 121 JANITOR
- 122 MEN 123 CORRIDOR
- 124 PAYMENTS 125 CITY MANAGER
- 126 CITY MANAGER RECEPTIONIST 127 H.R.
- 128 STORAGE
- 129 CLERK OF COUNCIL STORAGE
- 130 CORRIDOR 131 CLERK OF COUNCIL
- 132 VAULT 133 COUNCIL CONFERENCE ROOM
- 134 A.V. 135 VENDING
- 136 CORRIDOR

### MOTOR EQUIPMENT SCHEDULE

HP-1	Description: HEAT PUMP #HP-1 Voltage: 208V-1PH Load: 14.8 FLA Circuit Amps: 25 MCA, 35A/2P MOCP Branch Circuit: 2#10,#10GRD.,1/2"C.	Disconnect: Provide 60A-2P NEMA-3R fused service disconnect on outdoor unit. Interlock: Provide 14/3 with ground between indoor unit and outdoor unit.
HP-2	Description: HEAT PUMP #HP-1 Voltage: 208V-1PH Load: 14.8 FLA Circuit Amps: 25 MCA, 35A/2P MOCP Branch Circuit: 2#10,#10GRD.,1/2"C.	Disconnect: Provide 60A-2P NEMA-3R fused service disconnect on outdoor unit. Interlock: Provide 14/3 with ground between indoor unit and outdoor unit.
HP-3	Description: HEAT PUMP #HP-1 Voltage: 208V-1PH Load: 14.8 FLA Circuit Amps: 25 MCA, 35A/2P MOCP Branch Circuit: 2#10,#10GRD.,1/2"C.	Disconnect: Provide 60A-2P NEMA-3R fused service disconnect on outdoor unit. Interlock: Provide 14/3 with ground between indoor unit and outdoor unit.
HP-4	Description: HEAT PUMP #HP-1 Voltage: 208V-1PH Load: 14.8 FLA Circuit Amps: 25 MCA, 35A/2P MOCP Branch Circuit: 2#10,#10GRD.,1/2"C.	Disconnect: Provide 60A-2P NEMA-3R fused service disconnect on outdoor unit. Interlock: Provide 14/3 with ground between indoor unit and outdoor unit.
АН-В	Description: AH-B ROOFTOP UNIT Voltage: 208V-3PH Load: 53 FLA Circuit Amps: 48 MCA, 60A/3P MOCP Branch Circuit: 3#8,#10GRD.,3/4"C.	Disconnect: Circuit breaker disconnect provided with unit. Accessories: Integral convenience receptacle and power transformer.
АН-С	Description: AH-C ROOFTOP UNIT Voltage: 208V-3PH Load: 23 FLA Circuit Amps: 23 MCA, 30A/3P MOCP Branch Circuit: 3#12,#12GRD.,3/4"C.	Disconnect: Circuit breaker disconnect provided with unit. Accessories: Integral convenience receptacle and power transformer.
AH-D	Description: AH-D ROOFTOP UNIT Voltage: 208V-3PH Load: 25 FLA Circuit Amps: 25 MCA, 30A/3P MOCP Branch Circuit: 3#12,#12GRD.,3/4"C.	Disconnect: Circuit breaker disconnect provided with unit. Accessories: Integral convenience receptacle and power transformer.
EF-1	Description: EXHAUST FAN EF-1 Voltage: 120V-1PH Load: 13.4 W Circuit Amps: 20 MCA, 20A/1P MOCP Branch Circuit: 2#12,#12GRD.,1/2"C.	Disconnect: Provided with integral disconnect.  Control: Wall mounted combination fan & light motion sensor provided by the Electrical Contractor.
EF-2	Description: EXHAUST FAN EF-2 Voltage: 120V-1PH Load: 13.4 W Circuit Amps: 20 MCA, 20A/1P MOCP Branch Circuit: 2#12,#12GRD.,1/2"C.	Disconnect: Provided with integral disconnect.  Control: Wall mounted combination fan & light motion sensor provided by the Electrical Contractor.
EF-3	Description: EXHAUST FAN EF-3 Voltage: 120V-1PH Load: 22.4 W Circuit Amps: 20 MCA, 20A/1P MOCP Branch Circuit: 2#12,#12GRD.,1/2"C.	Disconnect: Provided with integral disconnect.  Control: Pilot light switch furnished by HVAC Contractor and wired by the Electrical Contractor.
EF-4	Description: EXHAUST FAN EF-4 Voltage: 120V-1PH Load: 17 W Circuit Amps: 20 MCA, 20A/1P MOCP Branch Circuit: 2#12,#12GRD.,1/2"C.	Disconnect: Provided with integral disconnect.  Control: Reverse action thermostat furnished by HVAC Contractor and wired by Electrical Contractor.
WH-1	Description: WALL HEATER WH-1 Voltage: 208V-1PH Load: 2 KW Circuit Amps: 12 MCA, 20A/2P MOCP Branch Circuit: 2#12,#12GRD.,1/2"C.	Disconnect: Provided with integral disconnect.

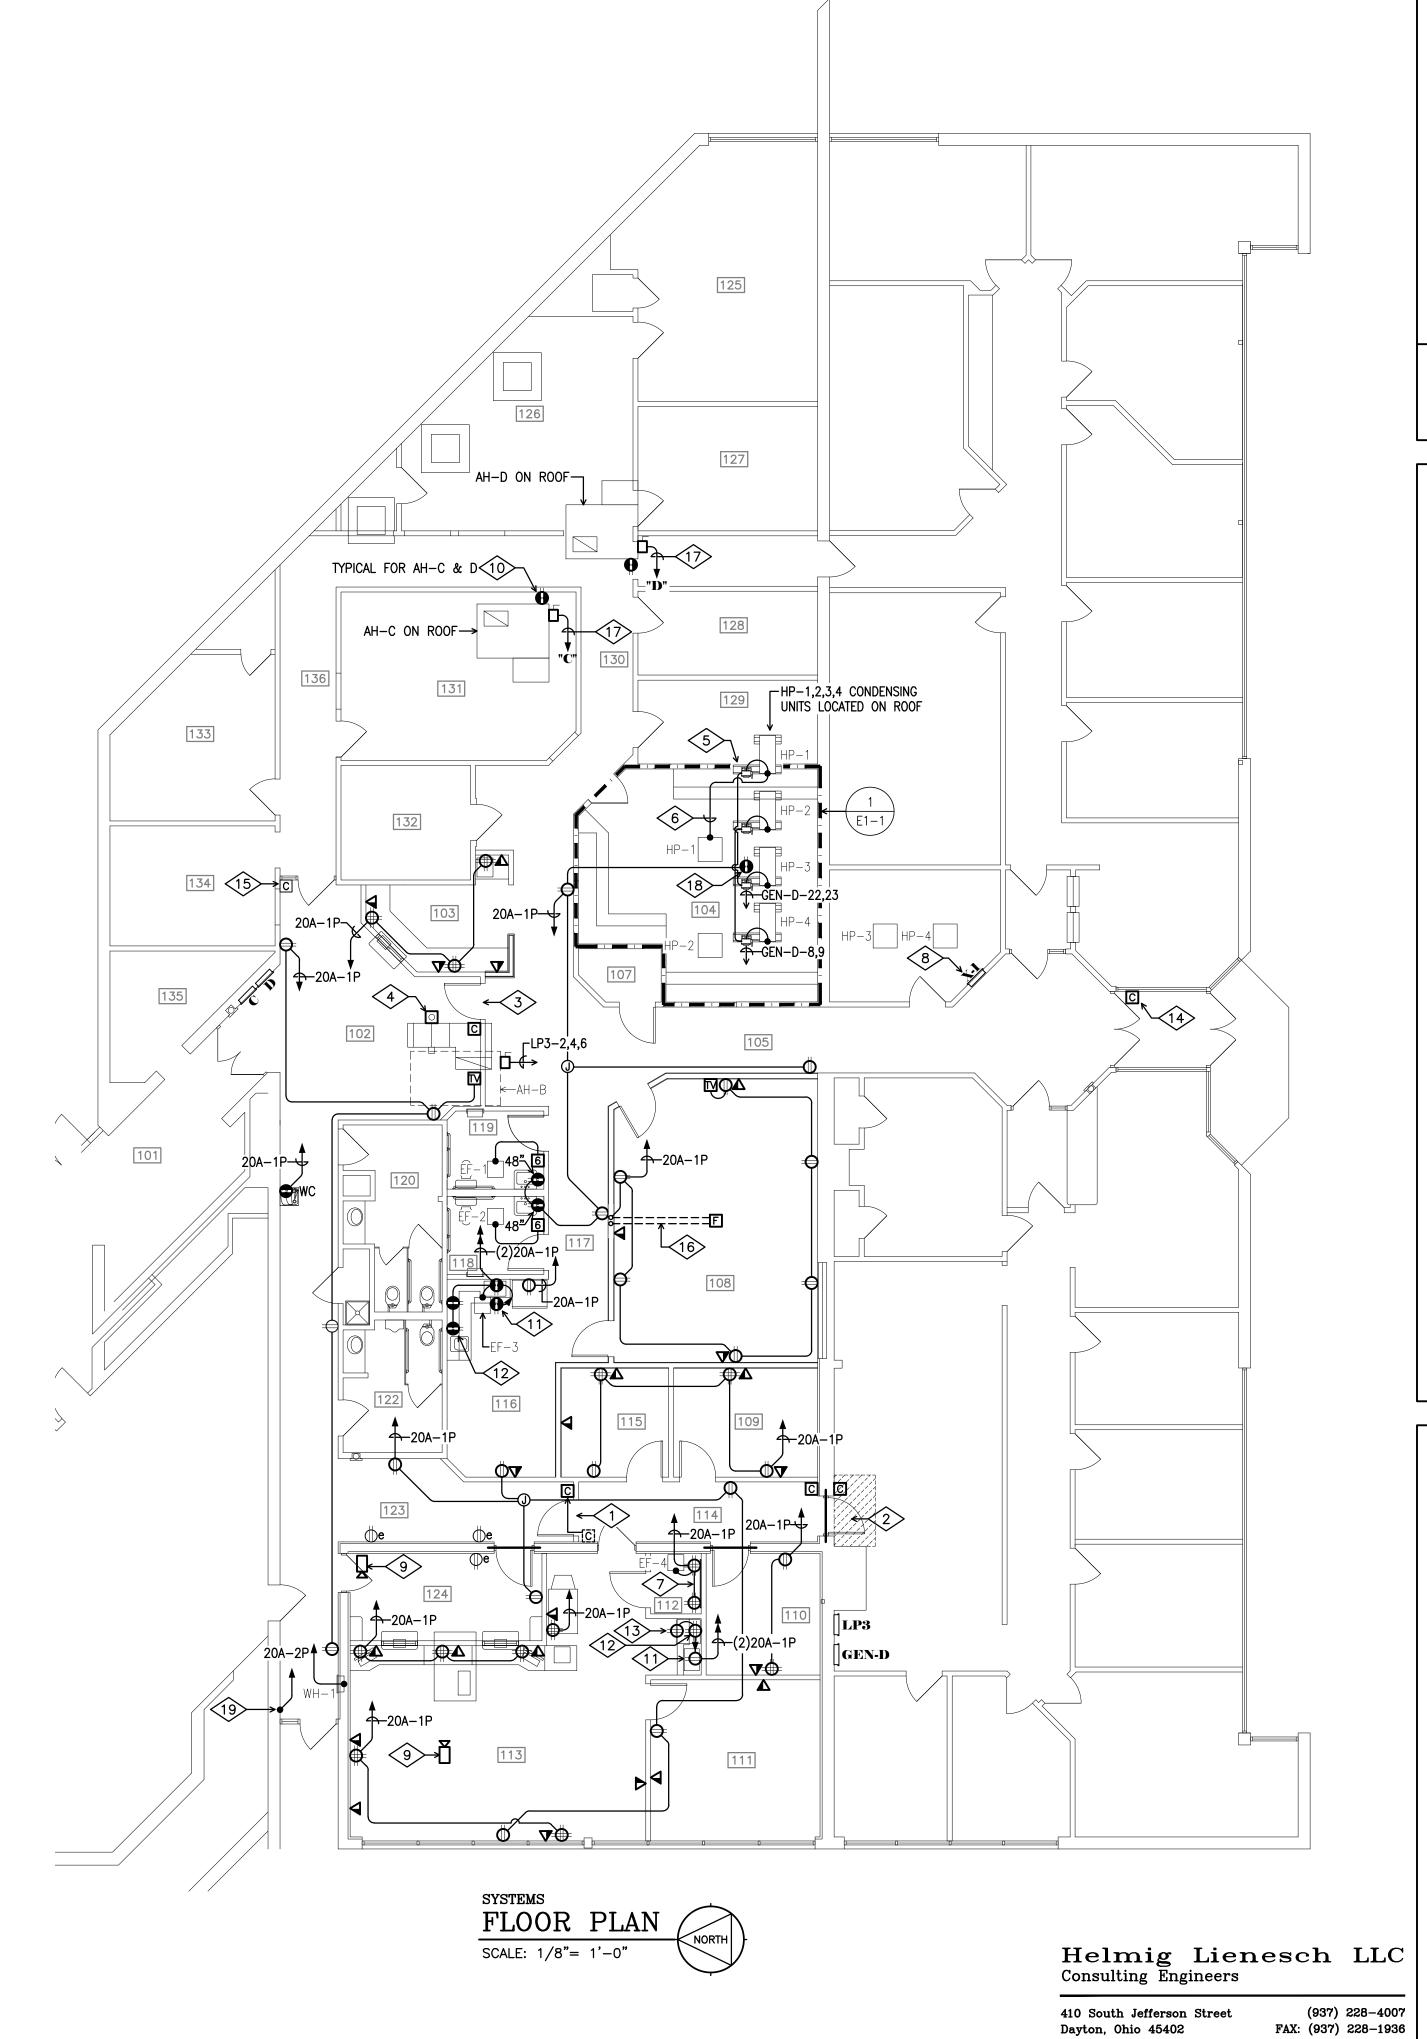

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MARCH 20, 2023

ELECTRICAL PARTIAL FIRST FLOOR SYSTEMS PLAN

Sheet Number

E2-2

PANEL: C VOLTA GE: 120/208V-3PH-4W TYPE: 225A M.L.O. CUTLER HAMMER CHB											LOCATION: WAITING 102 MOUNTING: FLUSH					
C.B.		KVA		LOAD	WIRE	C.B.		C.B.		WIRE	E LOAD	KVA			C.B	
NO.	A	В	С	DESCRIPTION	SIZE	POLE	AMP.	POLE	AMP.	SIZE	DESCRIPTION	A	В	С	NO	
1				LIGHTS FIN. DEPT.	12	1	20	1	20	12	LIGHTS FIN. DEPT.				2	
3				LIGHTS FIN. DEPT.	12	1	20	1	20	<b>{</b>	LIGHTS DIR.	<u> </u>			4	
5				LIGHTS DRAFTING	12	1	20	1	20	L	LIGHTS ENGINEER				6	
7				LIGHTS CITY MANAGER	12	1	20	1	20	<b></b>	LIGHTS SECY. CITY MGR.				8	
9				LIGHTS ROOM 141	12	1	20	1	20	12	LIGHTS BLDG. INSP.			····	10	
11				LIGHTS TELEP. & STOR.	12	1	20	1	20	12	LIGHTS COUNTER & VAULT				12	
13				RCPTS. FIN. DIR.	12	1	20	1	20	12	RCPTS. ENGINEER				14	
15				RCPTS. CITY MGR.	12	1	20	1	20	12	RCPTS. SECY & MGR.			····	16	
17				RCPTS. ENG. & RECS.	12	1	20	1	20	10	RCPTS. ROOM 141				18	
19				RCPTS. ROOM 141 & SECY.	12	1	20	1	20	12	RCPTS. BLDG INSP.				20	
21				RCPTS. ROOM 147 STOR.	12	1	20	1	20	12	RCPTS ROOM 144 & 145				22	
23				RCPTS COAT & COURT	12	1	20	1	20	12	RECEPTIONIST RCPTS.				24	
25				COPY ROOM	12	1	20	1	20	12	CLERK OFF. CREDIT CARD				26	
27				PAY PHONE	12	1	20	1	20	12	RECEPTIONIST RCPTS.				28	
29				COURT COMPUTER	12	1	20	1	20	LOCK	RECEPTIONIST RCPTS.				30	
31				TIME CLOSK	12	1	20	1	20	12	WORK ROOM RCPTS.				32	
33				VENDING MACHINE	12	1	20	1	20	12	RECEPTIONIST RCPTS.				34	
35				?		1	20								36	
37				?		1	20	3	20	OFF	AV TRANS. IN COUNCIL CHAMBERS				38	
39				?		1	20								40	
41				?		1	20	1			SPACE				42	

		AGE: 12		-3PH-4W CUTLER HAMMER CHB							LOCATION: WAITING 102 MOUNTING: SURFACE				
C.B.		KVA		LOAD	WIRE	C.1	B.	C.	В.	WIRE	LOAD		KVA		C.B
NO.	A	В	С	DESCRIPTION	SIZE	POLE	AMP.	POLE	AMP.	SIZE	DESCRIPTION	A	В	C	NO
1				LIGHTS RESTROOM		1	20	1	20		LIGHTS CONFERENCE				2
3				LIGHTS CORR. & ROOM 153		1	20	1	20		LIGHTS ATTY. & MAYOR				4
5				LIGHTS COUNCIL CLERK		1	20	1	20						6
7		***************************************		RCPTS. RESTROOM & CONF.	····	1	20	1	20		RCPTS. ATTORNEY				8
9				RCPTS. MAYOR		1	20	1	20		RCPTS. COUNCIL CLERK				10
11				RCPTS. GARAGE & ROOM 153		1	20	1	20		LIGHTS CONFERENCE				12
13		<b>†</b>		WATER COOLER		1	20	1	20						14
15				LIGHTS ENTRY CORR.		1		1	20	<u> </u>					16
17				LIGHTS COAT ROOM		1	20	1	20		CORR. 159 HEATER				18
19				SPARE		1		1	20		OFFICE RCPT. IN OLD GARAGE				20
21				EXH. FAN ROOF		1	20	1	20		SPARE				22
23						1	20	1			SPACE				24
25					OFF	2	20	1	20	TRIP	220V HEATER CITY MGR.				26
27					OFF	2	20	1	20						28
29				CAMERA REAR CITY HALL		1	20	2	20	OFF					30
31						2	30	2	20	OFF					32
33							30	1			SPACE				34
35				SPACE		1		1			SPACE				36
37				SPACE		1		1			SPACE				38
39				SPACE		1		1			SPACE				40
41				SPACE		1		1			SPACE				42

		GE: 120		3PH-4W SQUARE-D NQOD							LOCATION: ADMINISTRATION OFFICE MOUNTING: FLUSH	CE			
C.B.		KVA		LOAD	WIRE	C.1	B.	C.	В.	WIRE	LOAD		KVA		C.B
NO.	A	В	C	DESCRIPTION	SIZE	POLE	AMP.	POLE	AMP.	SIZE	DESCRIPTION	A	В	C	NO
1	1.00			148 LIGHTING		1	20			8		6.36			2
3		1.00		E. PRKG. LOT/2 POLE LGT.		1	20	3	60		NEW ROOFTOP UNIT AH-B		6.36		4
5			1.00	142,143 LIGHT		1	20			8				6.36	6
7	1.00	1.00		ENTRY LIGHT		1	20	1			SPACE				8
9		1.00	4 00	144,147 LIGHT		1	20	1	1		SPACE			2.00	10
11	1 00		1.00	SOUTH POLE LIGHT		1	20	1	20		FINANCE RCPT.	0.00		0.90	12
13	1.00	4.00		139 LIGHT		1	20	1	20		FINANCE RCPT.	0.90			14
15		1.20		COPY		1	20	1	20		FINANCE RCPT.		0.90		16
17	2.00			SPACE		1		1	-		SPACE	4.04			18
19	0.90	2.00		138 RCPT.		1	20	2	40		RTU-3 FINANCE INSIDE WALL	4.24	404		20
21		0.90	2.00	135 RCPT.		1	20	3	40		RTU-3 FINANCE INSIDE WALL		4.24	4.04	22
23	2.00		0.90	138 RCPT.		1	20	<u></u>	-					4.24	24
25	0.90	2.00		142 RCPT.		1 1	20	1	1	ļ	SPACE		2.00		26
27		0.90		148 RCPT.		1 1	20	1	20		139 RCPT.		0.90		28
29	0.00			SPACE		1		1			SPACE			<b> </b>	30
31	0.90			148 RCPT.		1	20	<u>'</u>	20		143 RCPT.	0.90			32
33				SPACE		1		1	20		144 RCPT.		0.90	0.00	34
35	4 00			SPACE		1		1	20	-	145 RCPT.			0.90	36
37	1.00			N.W. POLE LIGHT		1	20	1	20		146 RCPT.	0.90			38
39		0.90		138-135 RCPT. & HALL LTS.		1	20	1			SPACE				40
41			1.00	S.W. POLE LIGHT		1	20	1			SPACE		<u></u>		42

		GE: 12	0/208V-	3PH-4W QUARE-D NQOD							LOCATION: ADMINISTRATION OFFICE MOUNTING: FLUSH	E			
С.В.		KVA LOAD		WIRE	C.B.		C.B.		WIRE	LOAD	KVA			C.B.	
NO.	A	В	С	DESCRIPTION	SIZE	POLE	AMP.	POLE	AMP.	SIZE	DESCRIPTION	A	В	С	NO
1	0.90			RM. 134,136 FINANCE RCPT.		1	20					3.60			16
2		0.90		RM. 131,129 FINANCE RCPT.		1	20	3	40		RTU-1 COMM. DEV. FRONT		3.60		17
3			0.90	RM. 130,132 FINANCE RCPT.		1	20							3.60	18
4	1.20			RM. 148 HEAT CIRCUIT/MAP COPIER		1	20					3.60			19
5		0.90		RM. 137,139 FINANCE RCPT.		1	20	3	40		RTU-2 FINANCE FRONT		3.60		20
6			0.90	RM. 143 LOBBY, COMM. FD. RCPT.		1	20							3.60	21
7		····		RM. 139 FINANCE FRONT DESK.		1	20	2	50	8	HEAT PUMPS HP-1 & HP-3	3.08			22
8				SPARE		2	20		30	8	HEAT FOWES HE-T & HE-S		3.08		23
9				SPARE			20	1	20		KIP 6000/SCANNER PLOTTER			1.00	24
10	0.90			R. 147 ENGINEERS OFFICE RCPT.		1	20	1	20		COMPUTER RM. HIGH OUTLETS	0.90			25
11		1.00		RM. 129,131 FINANCE LIGHTS		1	20								
11		1.00		RM. 144,147 LIGHTS		1	20								
12			1.00	RM. 132,139 LIGHTS		1	20						3.00		26
			1.00	LIGHTING		1	20	3	100		COMPUTER RM. OUTLETS			3.00	27
13	0.90			COMPUTER RCPT.		1	20					4.80			28
14		0.10		DUCT DETECTORS		1	20	2	50	8	HEAT PUMPS HP-2 & HP-4		3.08		29
15			0.90	SERVER ROOM RCPTS.		1	20		30	8	TIEATT OWN OTH -2 GTH -4			3.08	30

		GE: 120		1PH-3W	PANE	LBC	OAR.	D S	СНЕ		LOCATION: SERVER ROOM MOUNTING: FLUSH				
C.B.	I IPE.	KVA	1.L.O. S	QUARE-D QOC24UF LOAD	WIRE	C.B.		C	C.B.		LOAD	KVA			C.B.
NO.	A	В	C	DESCRIPTION	SIZE		AMP.	<u> </u>	AMP.	WIRE SIZE	DESCRIPTION	A	B	С	NO.
1	0.90			SERVER ROOM RCPTS.		1	20								2
3	0.00	0.90		SERVER ROOM RCPTS.		1	20	3	20		SURGE PROTECTOR				4
5			0.90	SERVER ROOM RCPTS.		1	20								6
7	0.90			SERVER ROOM RCPTS.		1	20	1	20		SERVER ROOM RCPTS.	0.90			8
9		1.20		UPS #1		1	30	1	20		SERVER ROOM RCPTS.		0.90		10
11			1.20	UPS #2		1	30	1	20		?			0.90	12
13	1.20			UPS #3		1	30	1	20		?	0.90			14
15		***************************************		SPARE		1	30	1	20		SPARE				16
17				SPARE		1	30	1	20		SPARE				18
19				SPACE		1		1			SPACE				20
21				SPACE		1		1			SPACE				22
23				SPACE		1		1			SPACE				24
***************************************			IP. =	10.8 30.0		1		1			SPACE				24





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# City of Moraine Municipal Buildin 4200 Dryden Road Moraine, OH 45439

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2020-149/6614

MARCH 20, 2023

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Date

ELECTRICAL PANELBOARD SCHEDULES

Sheet Number

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